

PROPOSAL FOR 2013-1

CHILDREN'S WING ADDITION

LEON VALLEY PUBLIC LIBRARY

6425 EVERS, LEON VALLEY, TEXAS 78238

PROJECT ADDRESS

6425 EVERS RD.
LEON VALLEY, TX 78238-1453

LEGAL DESCRIPTION

CD 4445 P-3005 A058 741

LAND DESCRIPTION

81/4 AC. 17' NOT FARM SINGLE

2,980.00 ACRES 129,609.80 SQ FT

PROJECT CONTACTS

OWNER
CITY OF LEON VALLEY
6400 EL VERDE RD.
SAN ANTONIO, TX 78238-2399
PHONE: 210-648-1391
FAX: 210-664-6988
WWW.LEONVALLEYTX.GOV

ARCHITECT

RICHARD MOGAS & ASSOCIATES,
ARCHITECTS, AIA
317 LEXINGTON SUITE 414
SAN ANTONIO, TX 78215
PHONE: 210-226-2220
FAX: 210-226-1846
RMOGAS@RICHARDMOGAS.COM

CONTRACTOR

Crownhill Builders
8400 Blanco Rd. Ste. 302
San Antonio, TX 78216
P: 210-334-0751
F: 210-343-0751
Email: crownhill@cbincnet

STRUCTURAL:

ACCUTECH CONSULTING, LLC
909 NE LOOP 410 SUITE 900
SAN ANTONIO, TEXAS 78209
T (710) 920-5355 F (710)
330-5460
Email: matt@accutechusa.com

MECHANICAL/ELECTRICAL/PLUMBING:

HIG & ASSOCIATES INC.
10 NE LOOP 410 SUITE 1070
SAN ANTONIO, TEXAS 78216
T (710) 349-0800 F (710)
349-2736
Email: matt@hig-associates.com

CODE INFORMATION

STANDARDS AND REGULATIONS

APPLICABLE STANDARDS OF CONSTRUCTION INDUSTRY AND BUILDING CODES HAVE THE SAME FORCE AND EFFECT ON PERFORMANCE OF THE WORK AS IF COPIED DIRECTLY INTO CONTRACT DOCUMENTS.

GOVERNING REGULATIONS HAVE PRECEDENCE OVER NONREFERENCED STANDARDS, IN SO FAR AS DIFFERENT STANDARDS MAY CONTAIN OVERLAPPING OR CONFLICTING REQUIREMENTS.

CONTRACTOR IS RESPONSIBLE FOR COMPLIANCE TO THESE STANDARDS AND REGULATIONS AND FOR THE CONSTRUCTION PERMITS. THE INSTALLATION SHALL MEET THE MINIMUM STANDARD PRESCRIBED IN THE LATEST EDITION OF THE FOLLOWING STANDARDS:

1. BUILDING CODES: 2006 INTERNATIONAL BUILDING CODE

2. PLUMBING CODE: 2006 INTERNATIONAL PLUMBING CODE

3. MECHANICAL CODE: 2006 INTERNATIONAL MECHANICAL CODE

4. ELECTRICAL CODE: 2005 NATIONAL ELECTRIC CODE

5. FIRE/LEAVE SAFETY CODE: 2006 INTERNATIONAL FIRE/LEAVE SAFETY CODE

6. ADA: 2012 ADA REGULATIONS AND STANDARDS FOR ACCESSIBLE DESIGN

TYPE OF CONSTRUCTION (EXISTING BUILDING) 1 STORY, TYPE IIB

TYPE OF CONSTRUCTION (NEW ADDITION) 1 STORY, TYPE IIB

BUILDING HEIGHT

BUILDING AREAS

BUILDING ADDITION 3832 SF

SCALE FOOTAGE CALCULATIONS 51 SF

STACKS / READING AREA 10 SF

MECHANICAL WALLS, COLUMNS, ETC 211 SF

TOTAL SQUARE FOOTAGE 4230 SF

REMOVED AREA

RENOV 100 SF

WOMEN'S 100 SF

HEATING ROOM 442 SF

STORAGE 63 SF

JANITORS CLOSET 10 SF

TOTAL SQUARE FOOTAGE 715 SF

EXISTING LIBRARY 5310 SF

TOTAL AIR CONDITIONED SPACE 10235 SF

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GENERAL NOTES:

1. THE INTENT OF THE DRAWINGS AND SPECIFICATIONS IS TO PROVIDE FOR A WATER-TIGHT AND WEATHER-TIGHT BUILDING. THE CONTRACTOR SHALL REVIEW ALL DETAILS RELATING TO THIS INTENT AND BY ENTERING INTO THIS CONSTRUCTION CONTRACT UNDERSTANDS FOR ONE FULL YEAR THE ADEQUACY OF THESE DETAILS.

2. THE INTENT OF THE DRAWING IS TO PROVIDE FOR A PLUMB, LEVEL AND SQUARE STRUCTURE UNLESS OTHERWISE NOTED.

3. THE BUILDING SHALL BE CONSTRUCTED IN FULL COMPLIANCE WITH CURRENT INTERNATIONAL COMMERCIAL BUILDING CODE AND ALL OTHER APPLICABLE CODES, ORDINANCES AND REGULATIONS AS WELL AS THE DRAWINGS AND SPECIFICATIONS.

4. THE CONTRACTOR SHALL BE RESPONSIBLE FOR THE ACCURATE PLACEMENT OF THE BUILDING ON THE SITE AND SHALL VERIFY ALL DIMENSIONS AND EXISTING CONDITIONS. THE OWNER SHALL NOT BE RESPONSIBLE FOR CHANGES TO THE WORK DUE TO THE FAILURE OF THE CONTRACTOR TO FAMILIARIZE HIMSELF OR HERSELF WITH EXISTING CONDITIONS, DRAWINGS AND SPECIFICATIONS.

5. DO NOT SCALE THE DRAWINGS. ALL DIMENSIONS SHALL HAVE PREFERENCE OVER SCALE AND SHOULD BE FIELD VERIFIED AND CORROBORATED WITH WORK OF ALL TRADES.

6. DETAILS ARE MEANT TO SHOW METHOD AND MANNER OF ACCOMPLISHING WORK. MINOR MODIFICATIONS MAY BE REQUIRED TO SUIT JOB DIMENSIONS OR CONDITIONS, ALL INCLUDED AS PART OF THE WORK.

7. THE CONTRACTOR SHALL PROVIDE ALL PERMITS AND INSPECTIONS NECESSARY FOR THE PROPER EXECUTION OF THE WORK IN ACCORDANCE WITH APPLICABLE CODES AND GOVERNING REGULATIONS.

8. THE CONTRACTOR SHALL VERIFY ALL SIZES AND LOCATIONS OF ALL MECHANICAL AND ELECTRICAL PADS AND PANELS AS WELL AS POWER WATER AND DRAIN REQUIREMENTS FOR SUCH EQUIPMENT AND EQUIPMENT MANUFACTURERS.

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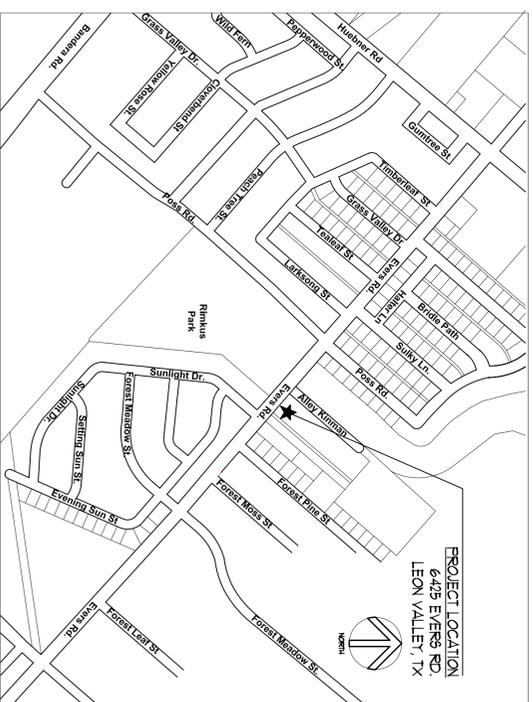
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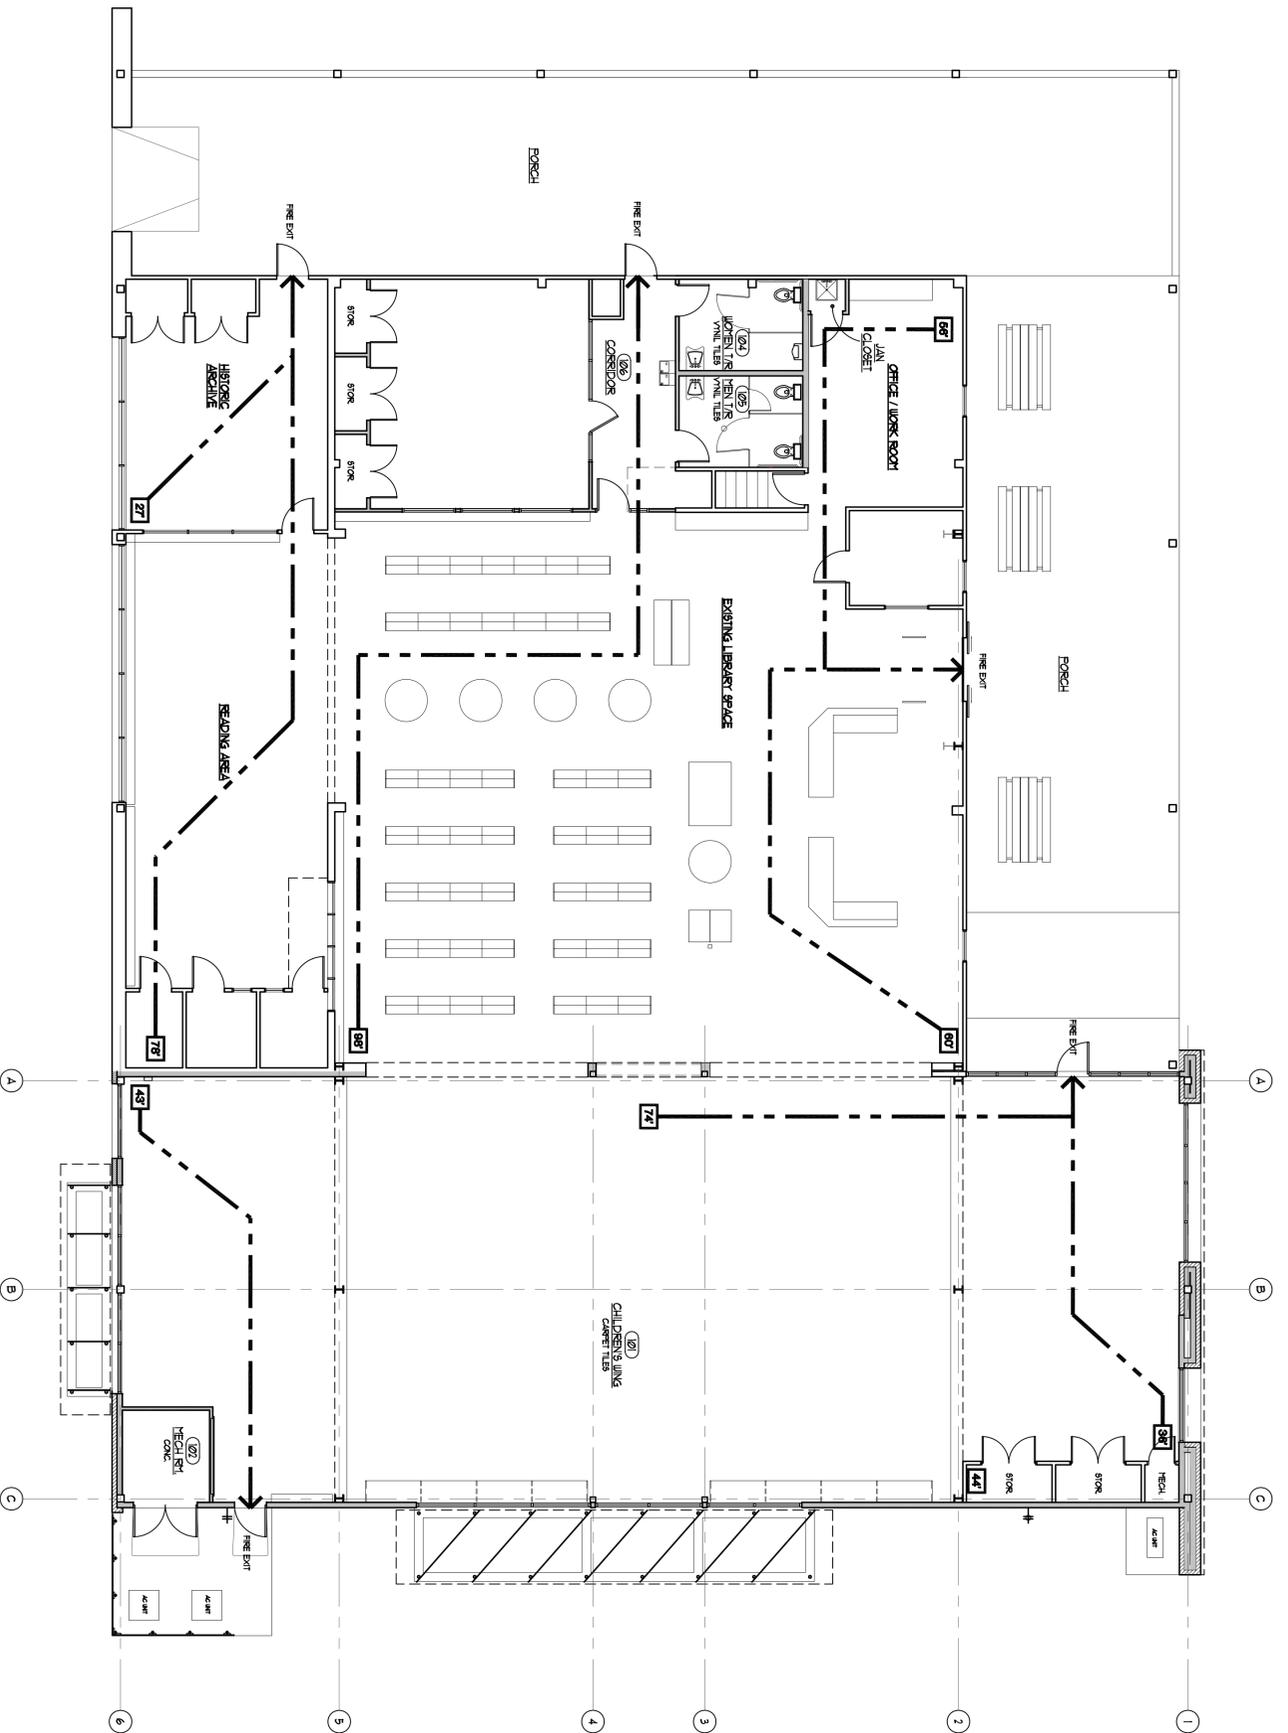


CONSTRUCTION DOCUMENTS

SHEET: G-1.0 1 OF 18 Date: NOV 16, 2012	COVER & INDEX OF DRAWINGS & GENERAL NOTES	Proposal for 2013-1 LEON VALLEY LIBRARY CHILDREN'S WING ADDITION 6425 Evers, Leon Valley, Texas 78238	RICHARD MOGAS ARCHITECTURE AIA 317 LEXINGTON AVENUE SUITE 4 SAN ANTONIO, TEXAS 78215 T 210 226 2220 F 210 226 1846 WWW.RICHARDMOGAS.COM MOGAS@RMOGAS.COM COMMERCIAL - RESIDENTIAL - REMODEL
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Expiration Date: 11/26/12



APPLICABLE BUILDING CODES
2006 INTERNATIONAL BUILDING CODE
2006 INTERNATIONAL FIRE CODE

OCCUPANCY CLASSIFICATION:
GROUP A - A-3 - LIBRARY
AUTOMATIC FIRE SUPPRESSION SYSTEM NOT PROVIDED

GROSS SF:
EXISTING BUILDING 6,025 SQ. FT.
ADDITION BUILDING 4,757 SQ. FT.
TOTAL GROSS SF 10,782 SQ. FT.

ALLOWABLE BUILDING HEIGHT AND AREAS

GROUP	TYPE	ALLOWABLE	ACTUAL
A-3	2 STOREYS	9,500 SQ. FT.	1 STORY
IB	FRONTAGE INCREASE	7,125 SQ. FT.	
	ALLOWABLE	16,625 SQ. FT.	10,782 SQ. FT.

CONSTRUCTION CLASSIFICATION (TABLE 601.1 BC 2006):

TYPE	REQUIREMENT	PROVIDED
TYPE IIB	STEEL FRAMING	0 HR
	BEARING WALLS	0 HR
	EXTERIOR	0 HR
	NONBEARING WALLS & INTER. PARTITIONS	0 HR
	ROOF CONSTRUCTION	0 HR
	FLOOR CONSTRUCTION	0 HR
	WALL CONSTRUCTION	0 HR

EXIT ACCESS (TABLE 1016.1 BC 2006)
TRAVEL DISTANCE TO CLOSEST EXIT NOT TO EXCEED 200 FT.
ACTUAL MAXIMUM TRAVEL DISTANCE: 112 FT

OCCUPANCY LOADS (PER TABLE 1006.1.1 BC 2006)

AREA	LOAD	TOTALS	TOTAL BUILDING
LIBRARY	100 GR.	67.94	67.94
STACK AREA	50 NET.	18.86	18.86
READING RM.	15 GR.	29.46	29.46
ASSESSMENT UNCON.	300 GR.	1.19	1.19
OFFICE	300 GR.	1.19	1.19
ACCESSORY AREA	300 GR.	1.19	1.19
TOTAL			125

EGRESS REQUIREMENTS (PER TABLE 1006.1 BC 2006)

WITHOUT A SPRINKLER SYSTEM	WITH SPRINKLER SYSTEM
Code Requirement (in. per occ.)	Code Requirement (in. per occ.)
3"	3"
TOTAL BUILDING (200 OCC.)	30"

EGRESS: 3 REQUIRED, 5 PROVIDED

PLUMBING EXISTING REQUIREMENTS (PER TABLE 2902.1 BC 2006)

DESIGN OCCUPANCY TOTALS	MALE	FEMALE	TOTAL
TOTAL BUILDING	75	75	150

NUMBER OF PLUMBING FIXTURES (PER TABLE 2902.1 BC 2006)

OCC. USER	LOAD	#/C.	MALE	FEMALE	DRINK	SERVICE
GROUP	75M	1/200	1	2	1	1
	75F	1/200	2	2	1	1
REQUIRED	75M	1	1	2	1	1
PROVIDED	75M	2	2	2	1	1
	75F	2	2	2	1	1

LEGEND

- EXIT PATH
- DISTANCE TO EXIT
- DEMOTED EXIT
- FIRE EXTINGUISHER LOCATIONS

EGRESS PLAN

PLAN NORTH
SCALE: 1/8" = 1'-0"

CONSTRUCTION DOCUMENTS



SHEET: **G-1.1**
2 OF 18
Date: NOV 16, 2012

SHEET TITLE
CODE AND EGRESS PLAN

Proposal for 2013-1
LEON VALLEY LIBRARY
CHILDREN'S WING ADDITION
6425 Evers, Leon Valley, Texas 78238

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317 LEXINGTON AVENUE SUITE 4 SAN ANTONIO, TEXAS 78215
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MOGAS@IUNO.COM. COMMERCIAL - RESIDENTIAL - REMODEL



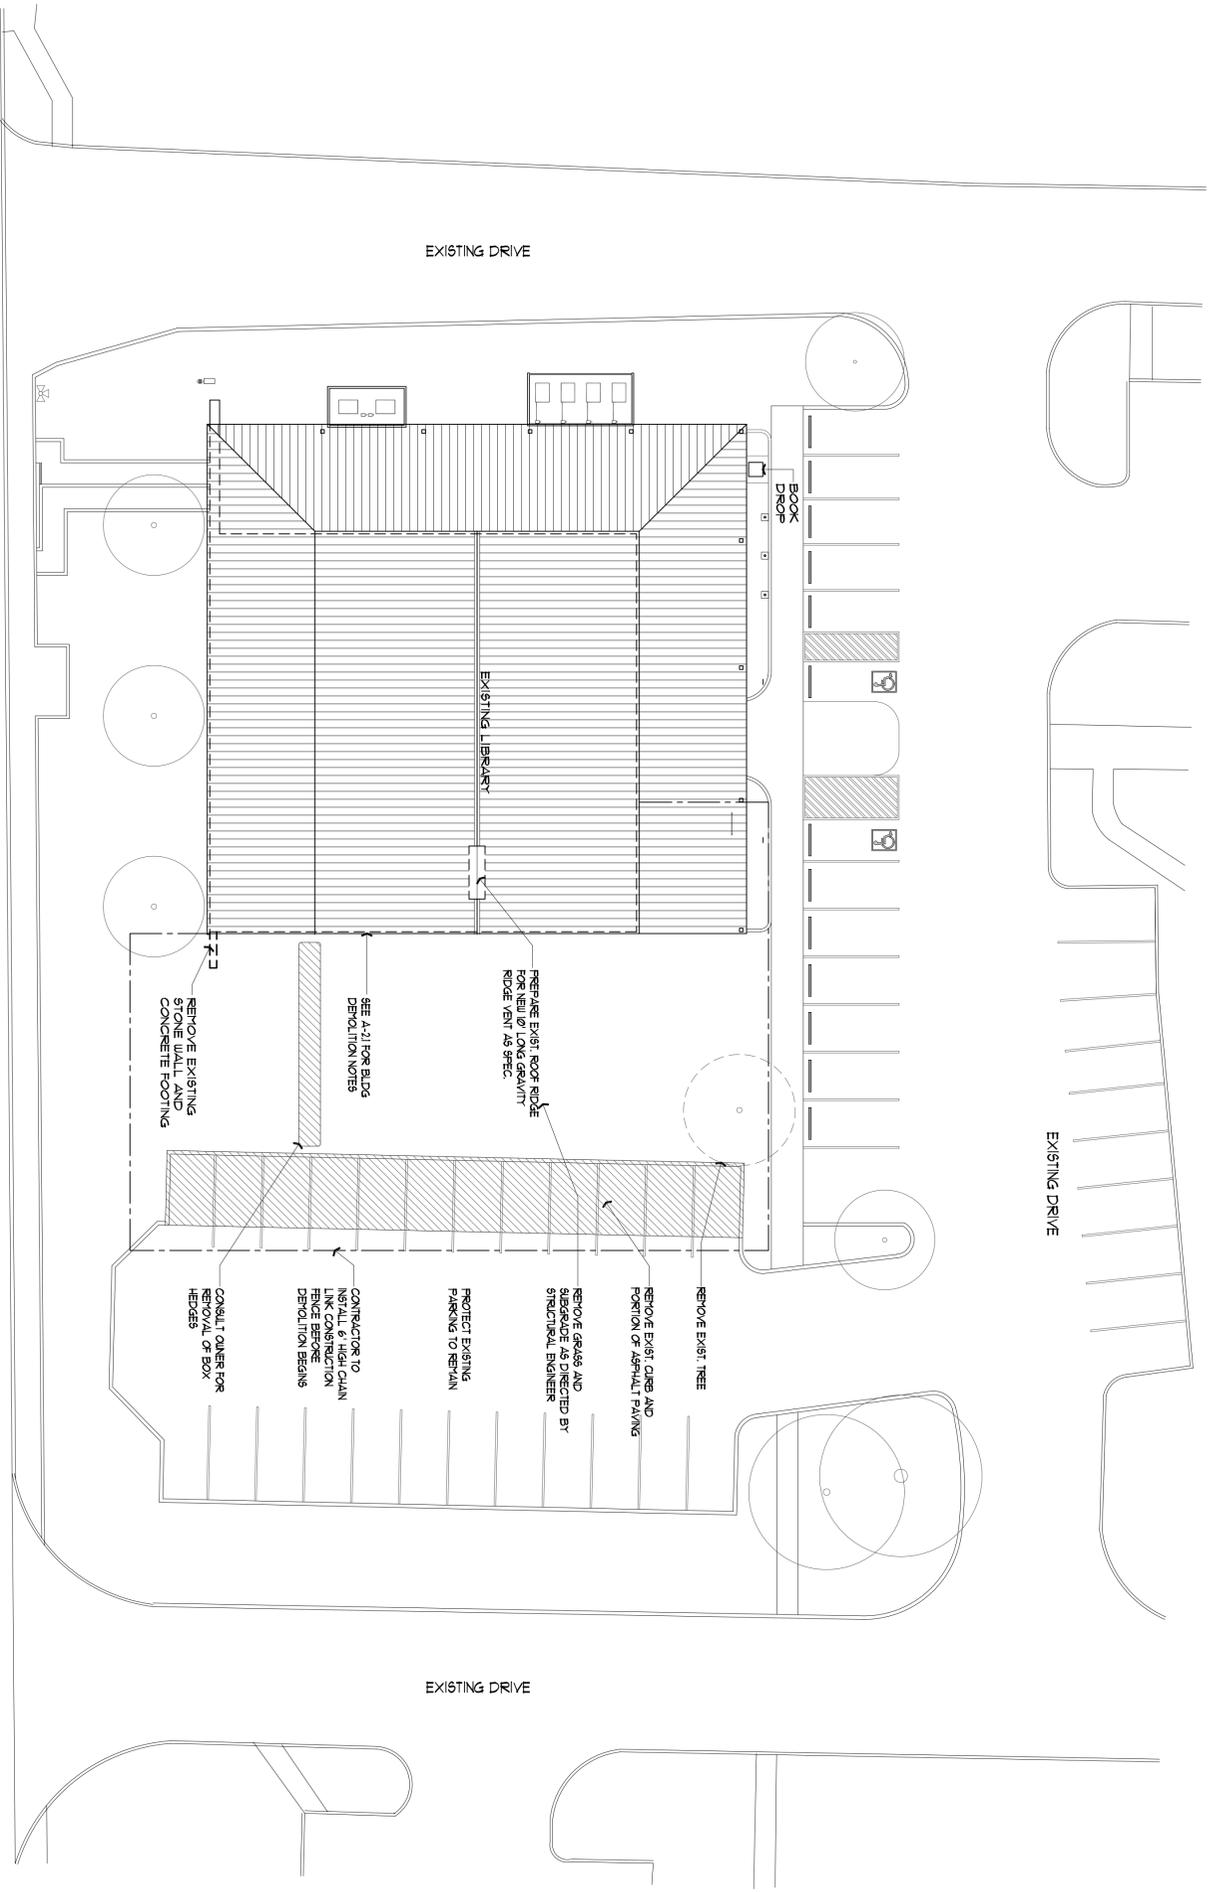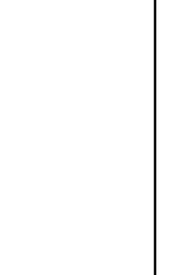

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DEMOLITION SITE PLAN

SHEET TITLE


CONSTRUCTION DOCUMENTS

SHEET:

A-1.1

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 Date: NOV 16, 2012

DEMOLITION SITE PLAN

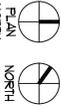

PLAN NORTH



PLAN NORTH


SCALE: 1/16" = 1'-0"

EVERS ROAD

EXISTING DRIVE

EXISTING DRIVE

EXISTING DRIVE

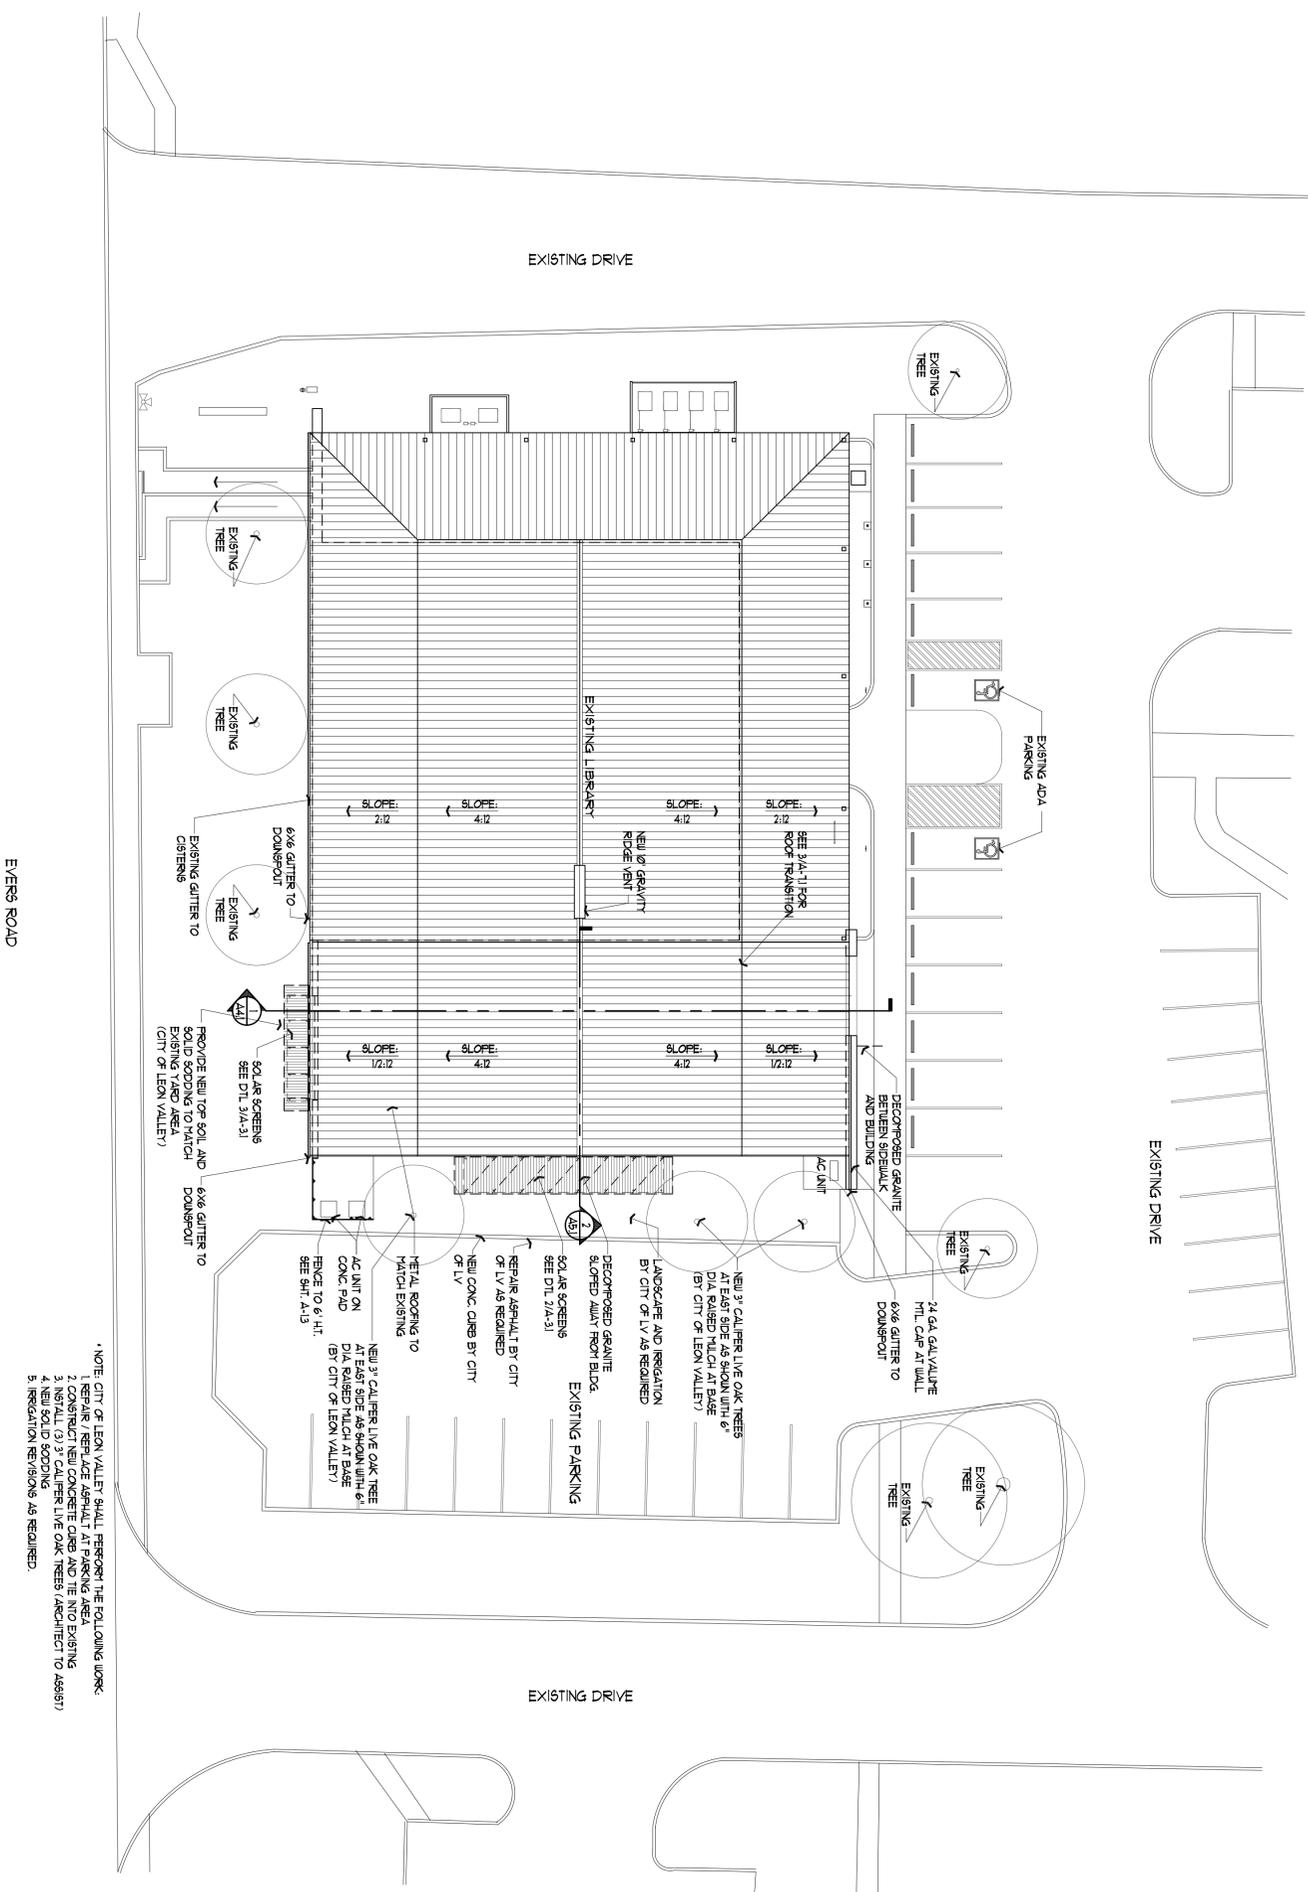

- NOTE: CITY OF LEON VALLEY SHALL PERFORM THE FOLLOWING WORK:
1. REPAIR / REPLACE ASPHALT AT PARKING AREA
 2. CONSTRUCT NEW CONCRETE CURB AND TIE INTO EXISTING
 3. NEW 4\"/>

 PLAN NORTH
 NORTH
NEW SITE PLAN
 SCALE: 1/16" = 1'-0"
 SHEET: A-1.2
 4 OF 18
 Date: NOV. 16, 2012


CONSTRUCTION DOCUMENTS

SHEET:	A-1.2
SHEET TITLE	NEW SITE PLAN


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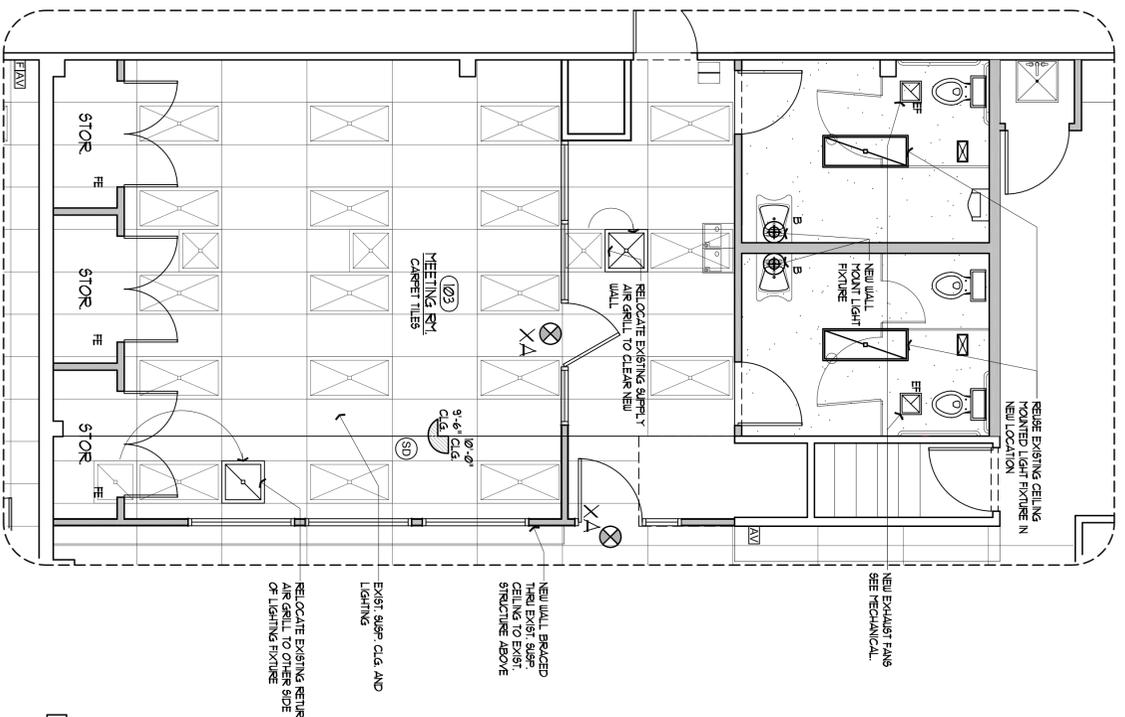




ENLARGED
RESTROOM PLAN
SCALE: 1/4" = 1'-0"
PLAN NORTH

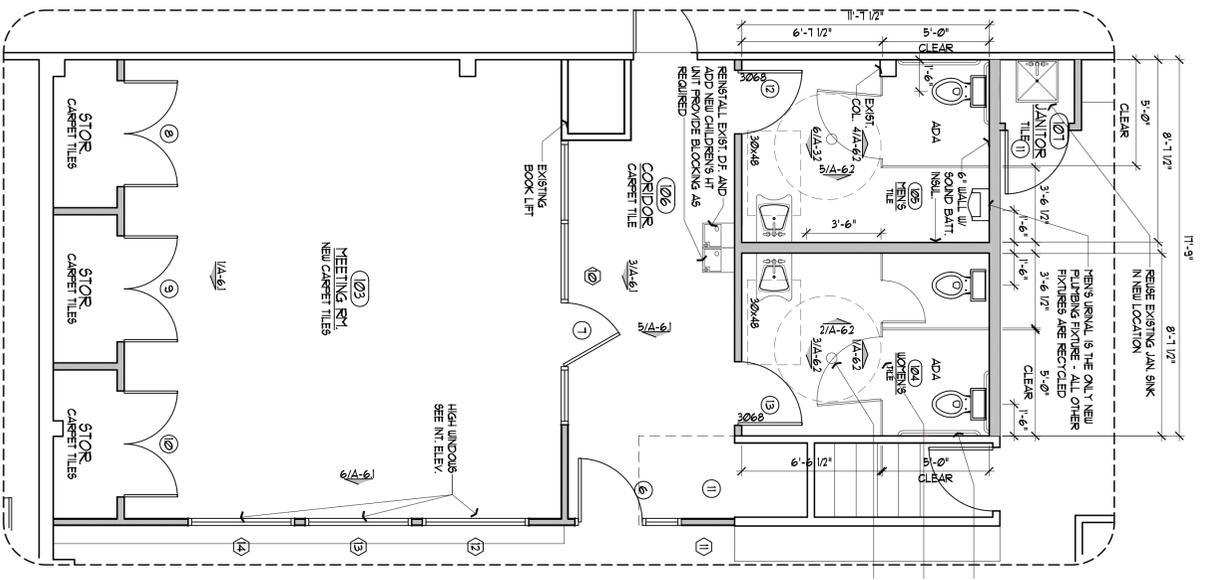


FLOOR PLAN
SCALE: 1/8" = 1'-0"
PLAN NORTH

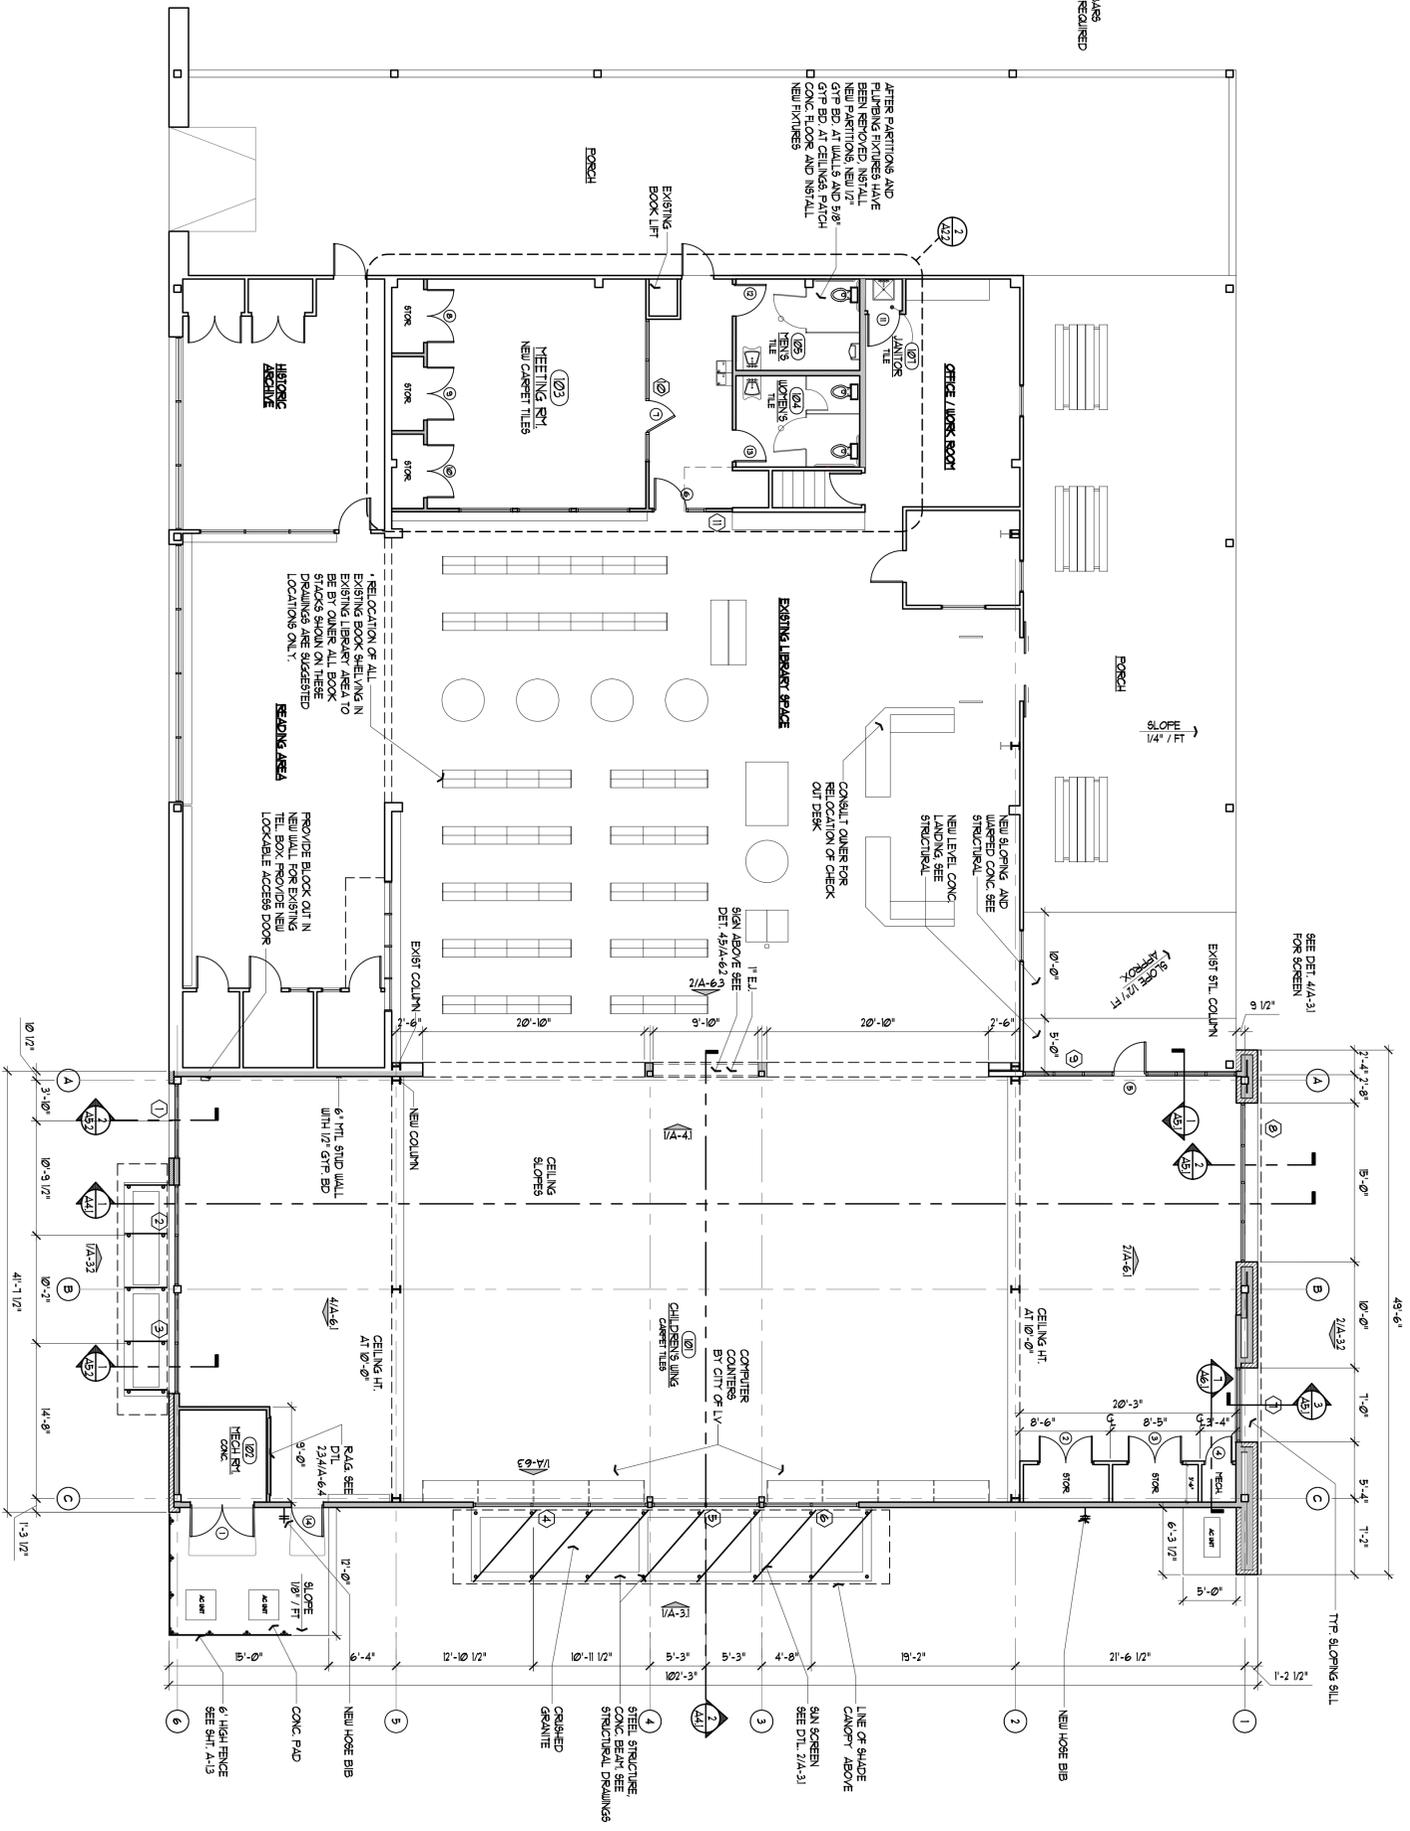


ENLARGED - REFLECTED
RESTROOM PLAN
 SCALE: 1/4" = 1'-0"


- CEILING SYMBOL LEGEND**
- A METAL FINISH WALL SCONCE
 - AD ADJUSTABLE DOOR ALIGHT AT EXIT
 - B WALL SCONCE AT TOILET ROOMS (ALLOW 1000 EAU)
 - Y4 EXIT LIGHT
 - E DEL. & FLUORESCENT TUBES AT SIGN
 - FA PENDANT SUSPENDED LIGHT - HANG TO 1'-0" AFF.
 - FB WALL SCONCE WITH ALIGHT HOUSING FINISH - EXTERIOR GRADE METAL
 - FD 8" DIA. RECESSED LIGHT FIXTURE
 - FE 12X4 OPEN STRIP FIXTURE WITH LINE GUARD MOUNT TO WALL
 - FE 12X4 OPEN STRIP FIXTURE WITH LINE GUARD MOUNT TO WALL

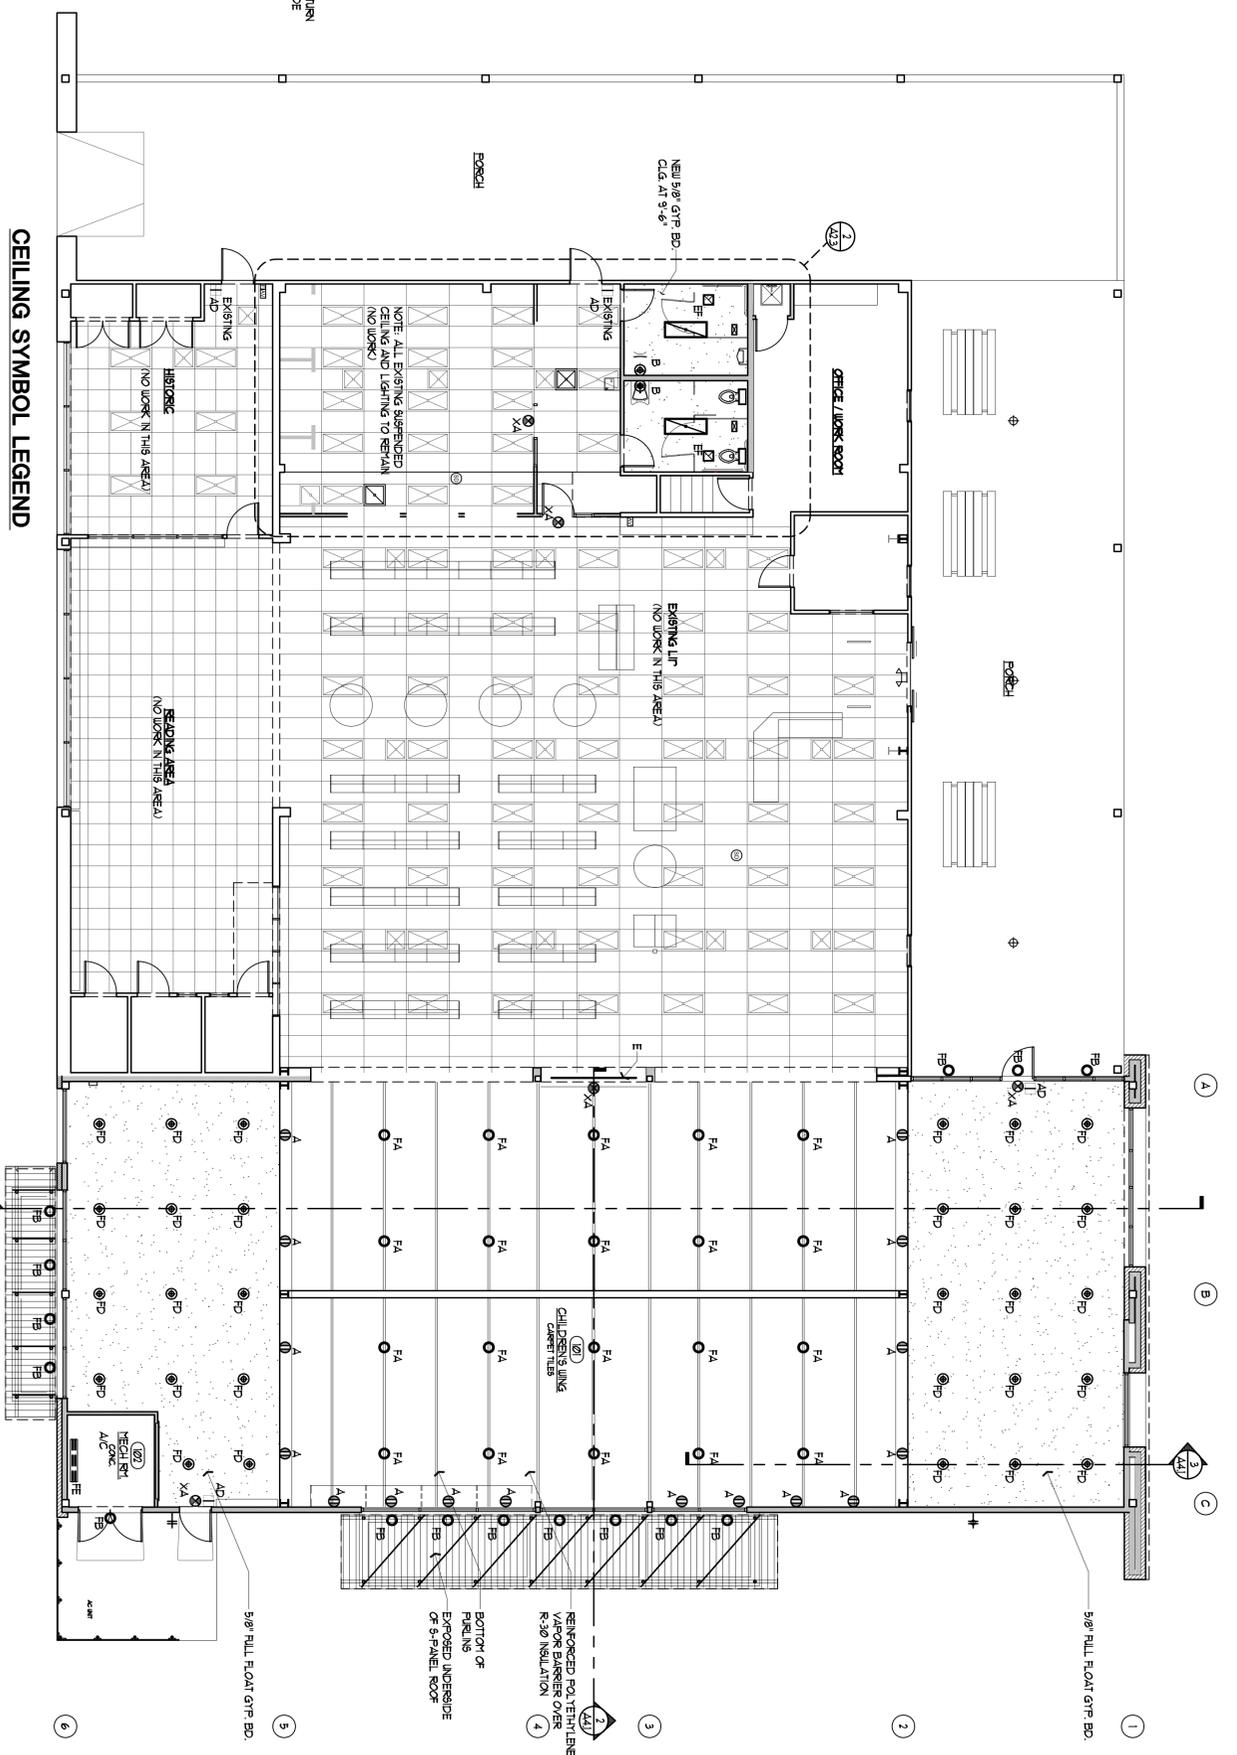


REFLECTED
CEILING PLAN
 SCALE: 1/8" = 1'-0"

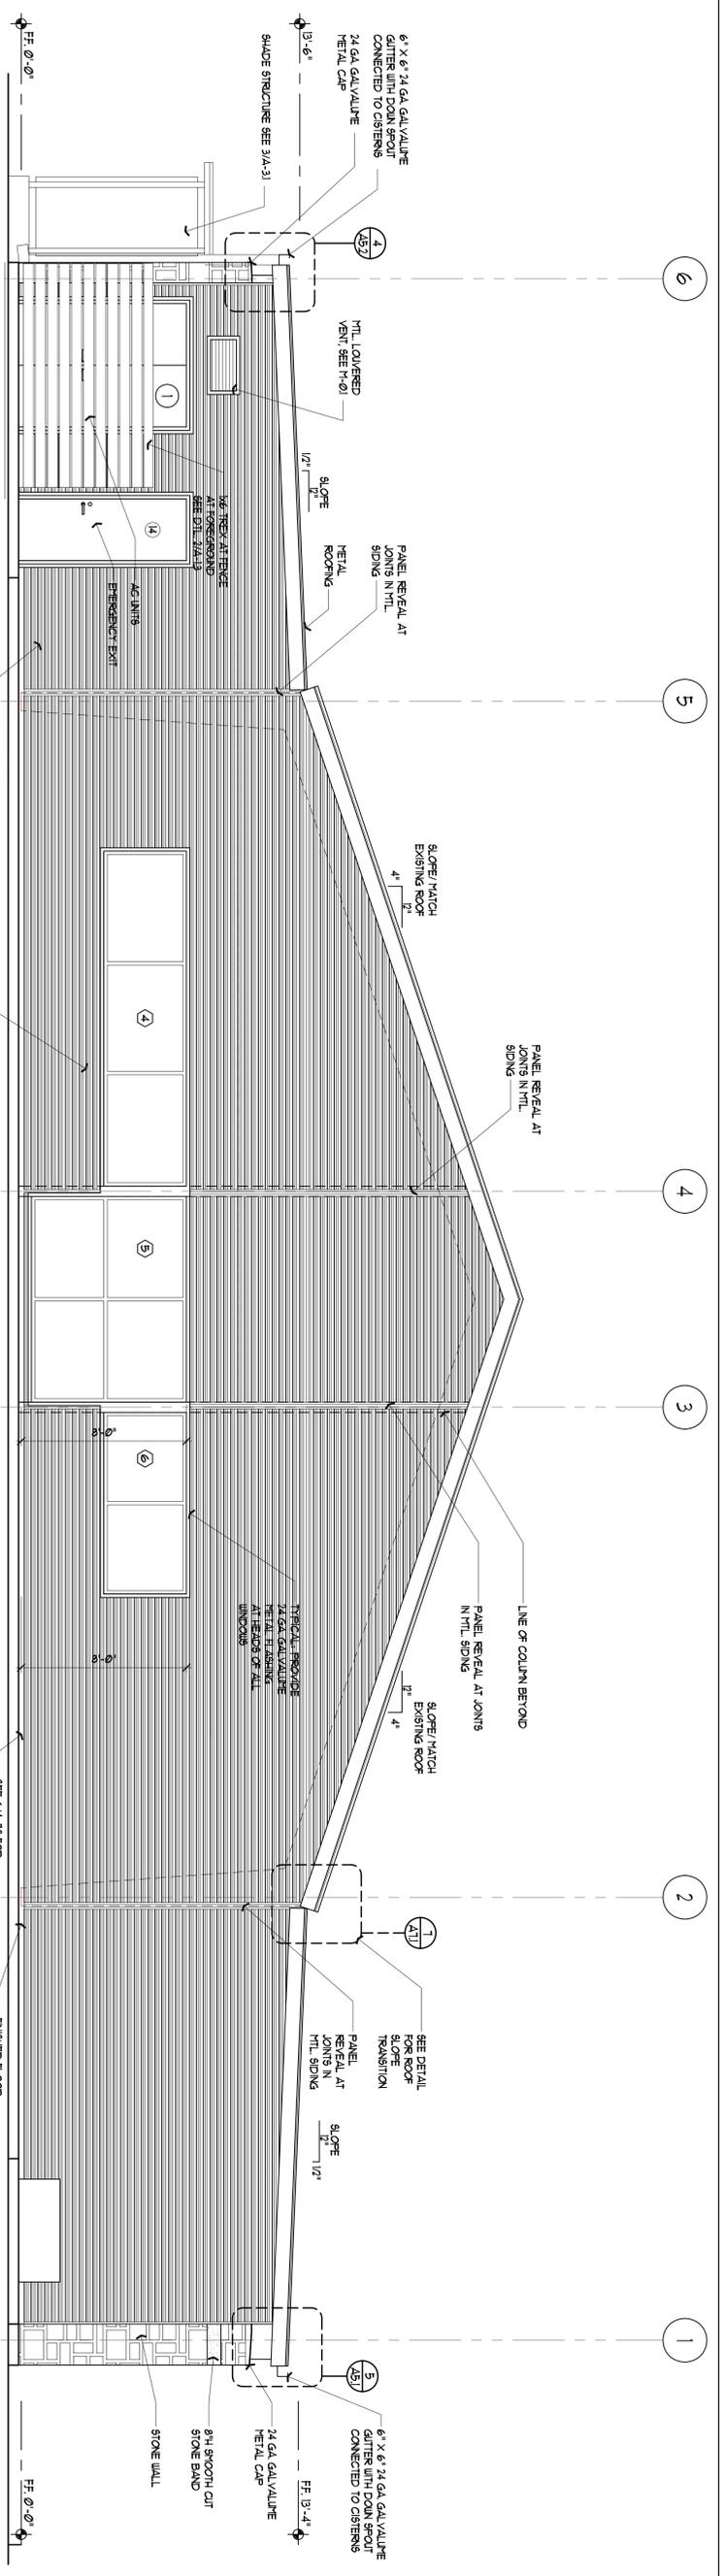


EAST ELEVATION
SCALE: 1/4" = 1'-0"

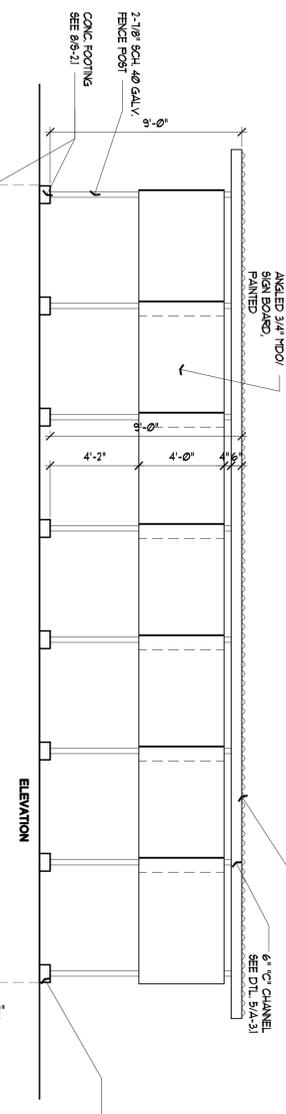


2 EAST SUN SCREEN
SCALE: 1/4" = 1'-0"

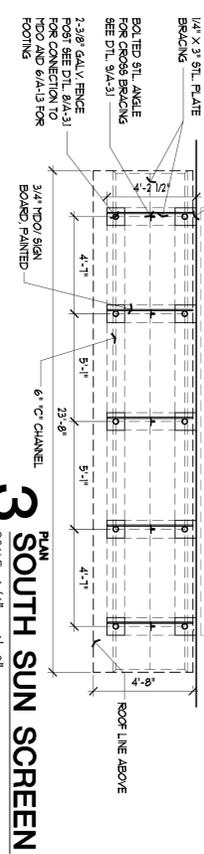


3 SOUTH SUN SCREEN
SCALE: 1/4" = 1'-0"

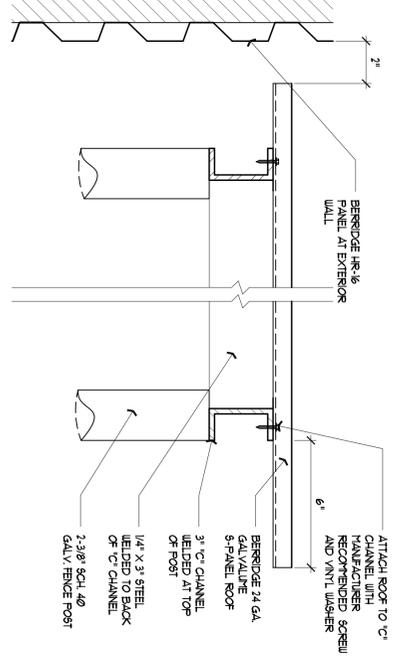


5 DETAIL
SCALE: 3" = 1'-0"

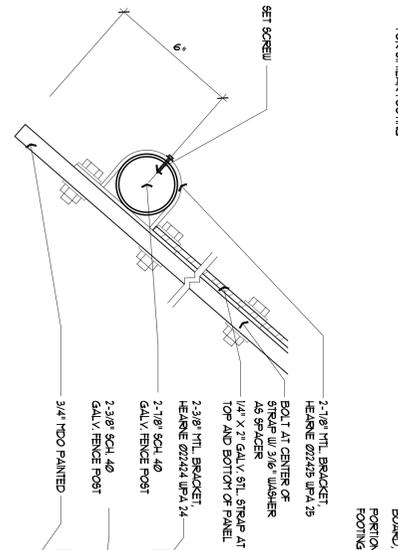

6 DETAIL
SCALE: 3" = 1'-0"

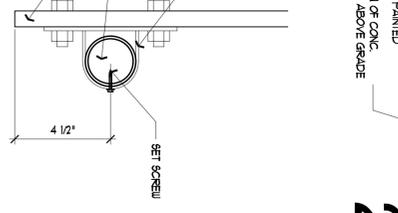

7 DETAIL
SCALE: 3" = 1'-0"

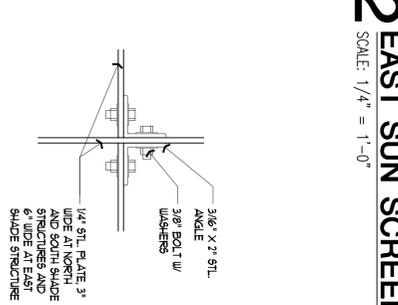


8 DETAIL
SCALE: 3" = 1'-0"




9 DETAIL
SCALE: 3" = 1'-0"




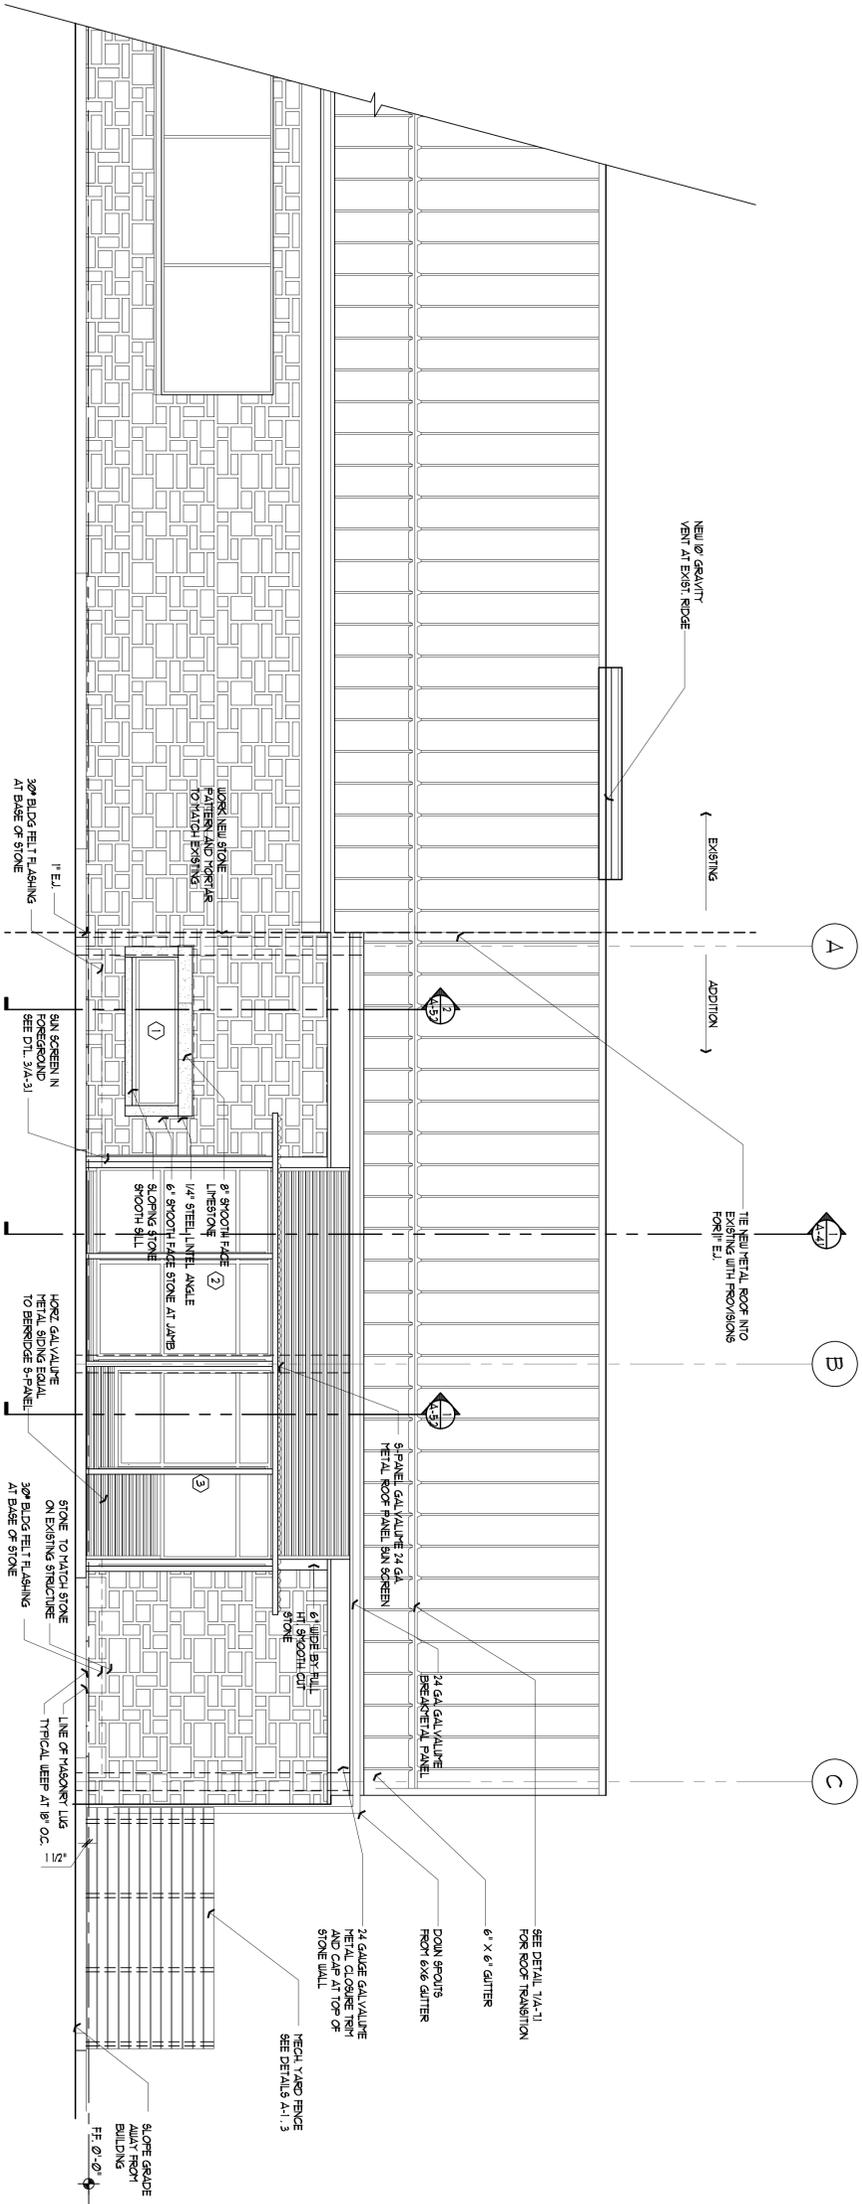

PARTIAL SOUTH ELEVATION
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PARTIAL NORTH ELEVATION
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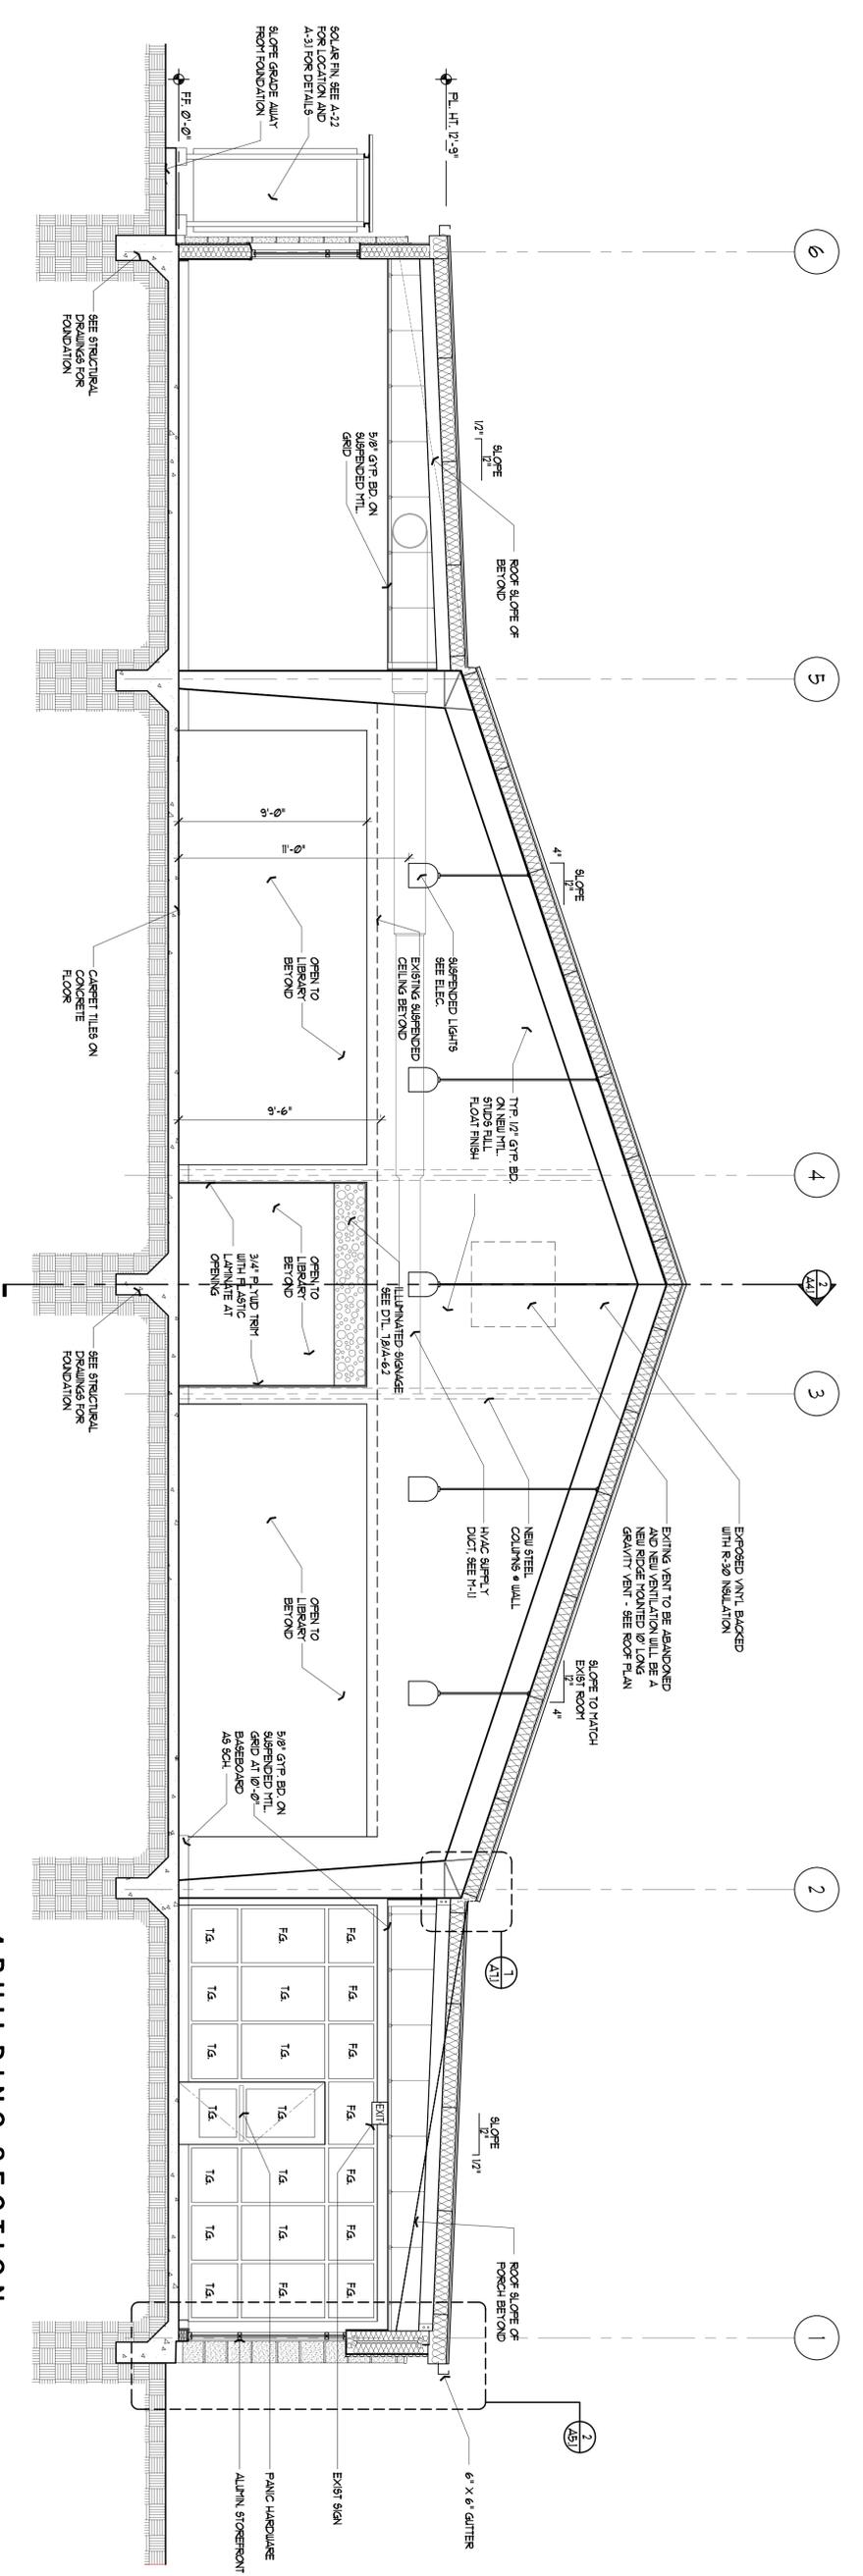
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EXTERIOR ELEVATIONS

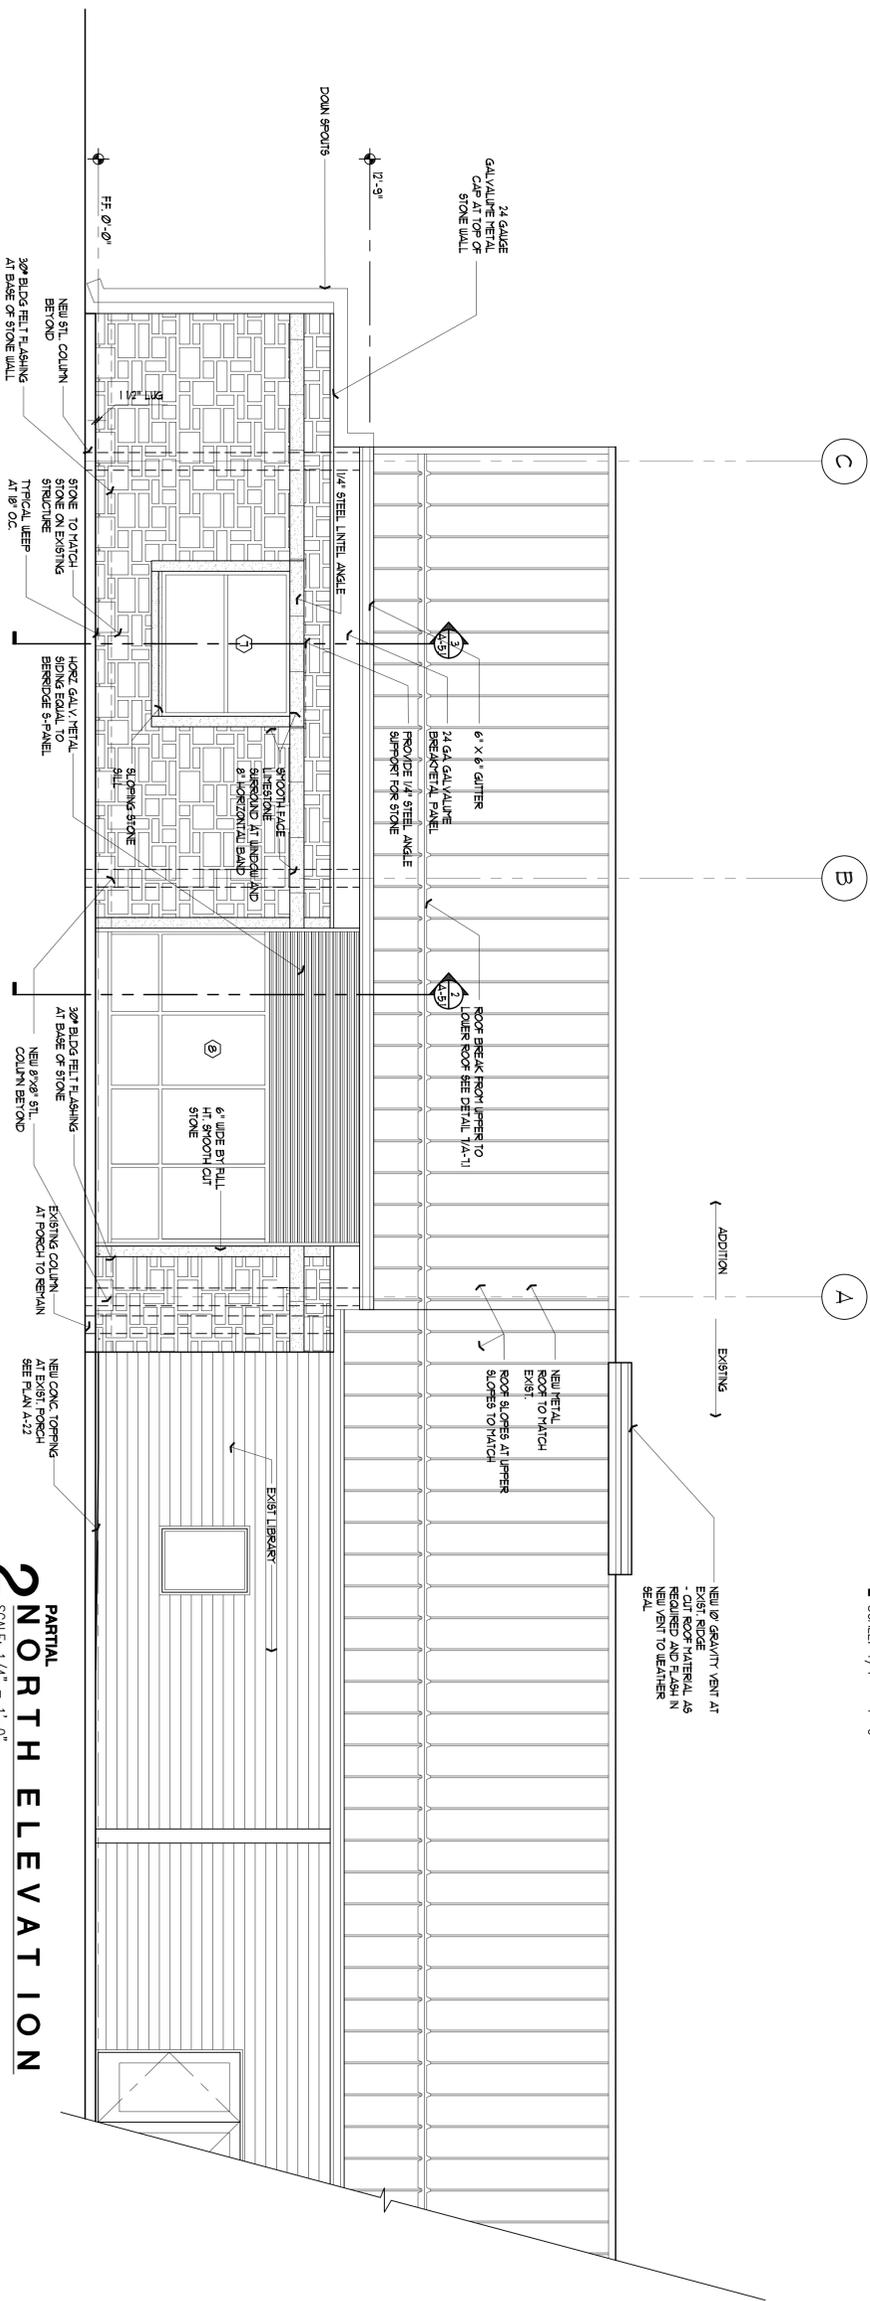
SHEET TITLE

CONSTRUCTION DOCUMENTS

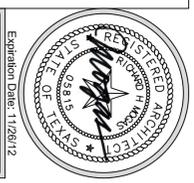SHEET: **A-3.2**
10 OF 18
Date: NOV 16, 2012



BUILDING SECTION
SCALE: 1/4" = 1'-0"

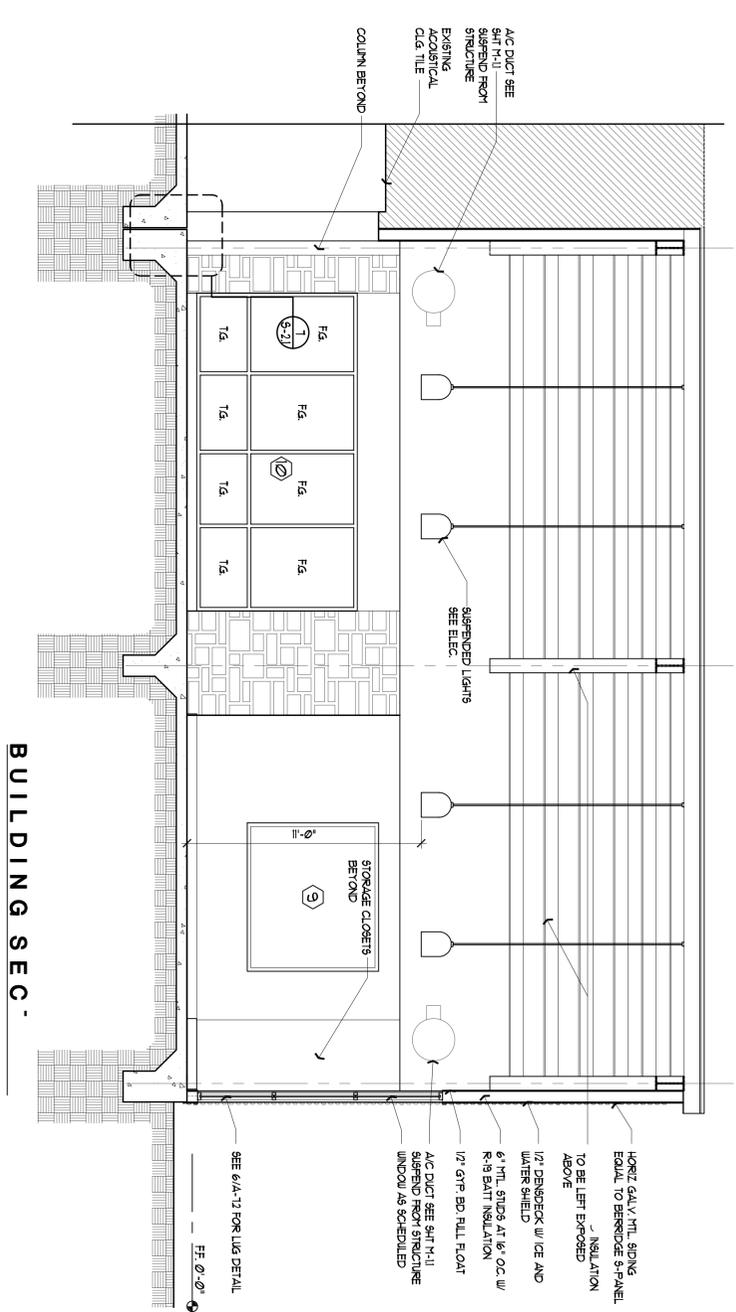

- HORIZ. GALV. TILT. SIDING EQUAL TO BERBERGE & PANEL ABOVE
- INSULATION
- TO BE LEFT EXPOSED
- 1/2" DENSICORE W/ ICE AND WATER SHIELD
- 6" TYP. STIPS AT 16" O.C. W/ R-12 BATT INSULATION
- 1/2" GYP. BD. FULL FLOAT
- A/C DUCT SEE SHIT M-11 SUPPORT FROM STRUCTURE WINDOW AS SCHEDULED
- SEE 6/4-12 FOR LUG DETAIL
- FF: 0'-0"

BUILDING SEC.



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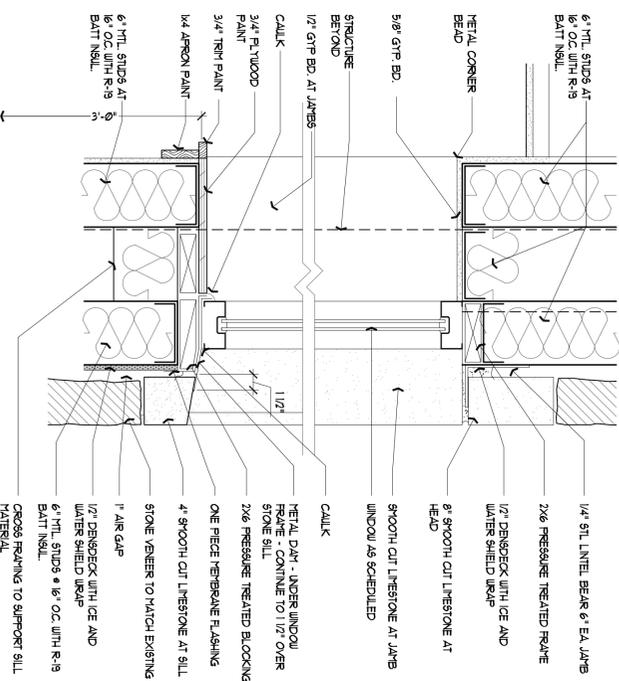
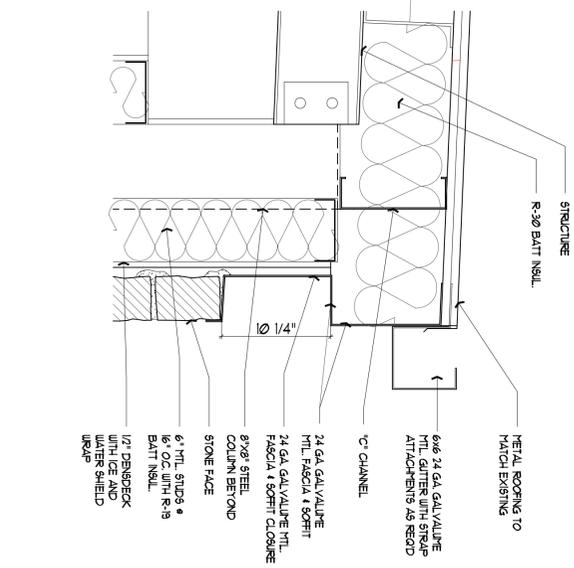
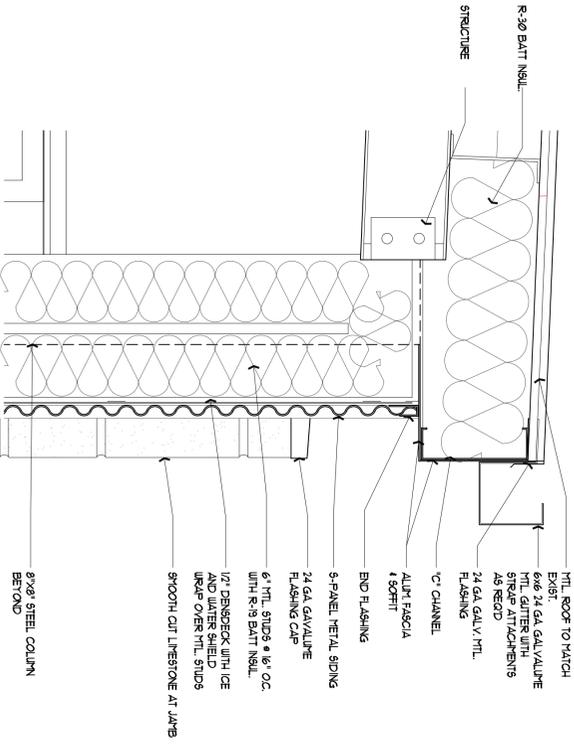




1 SECTION
SCALE 3/4" = 1'-0"

2 SECTION
SCALE 3/4" = 1'-0"

3 SECTION
SCALE 3/4" = 1'-0"

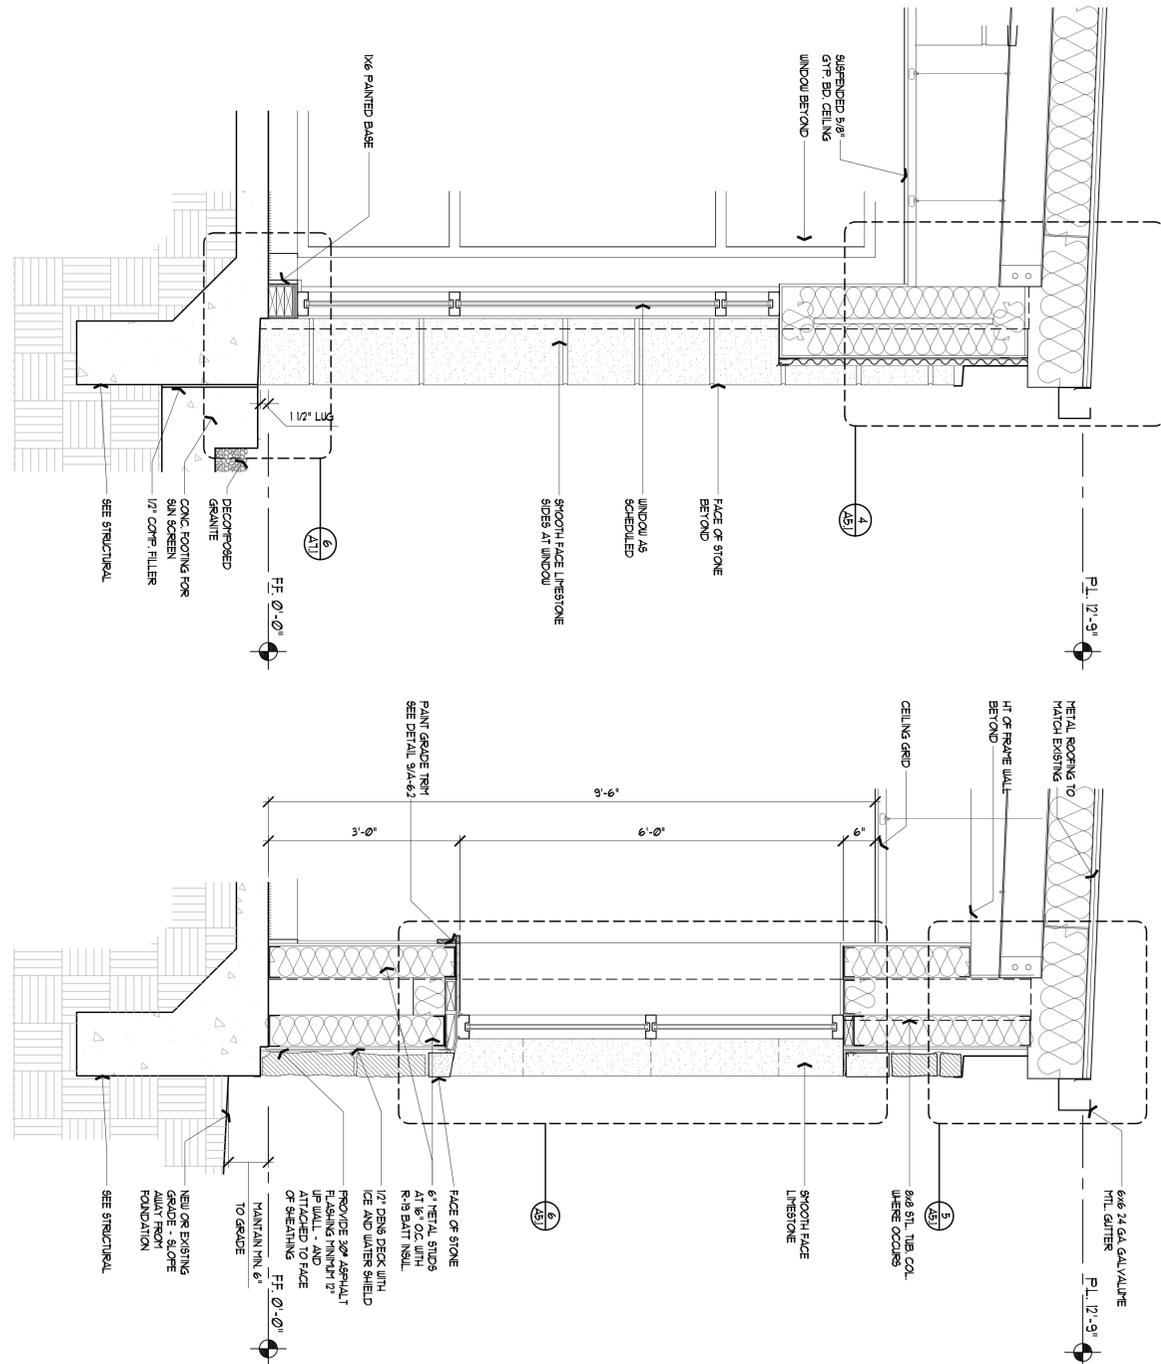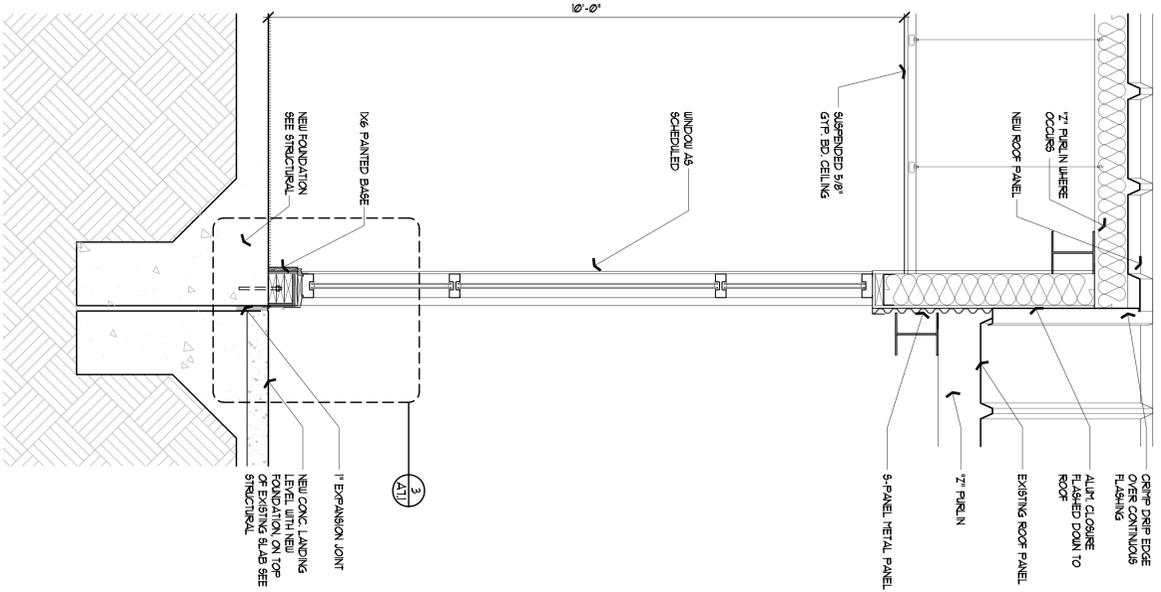



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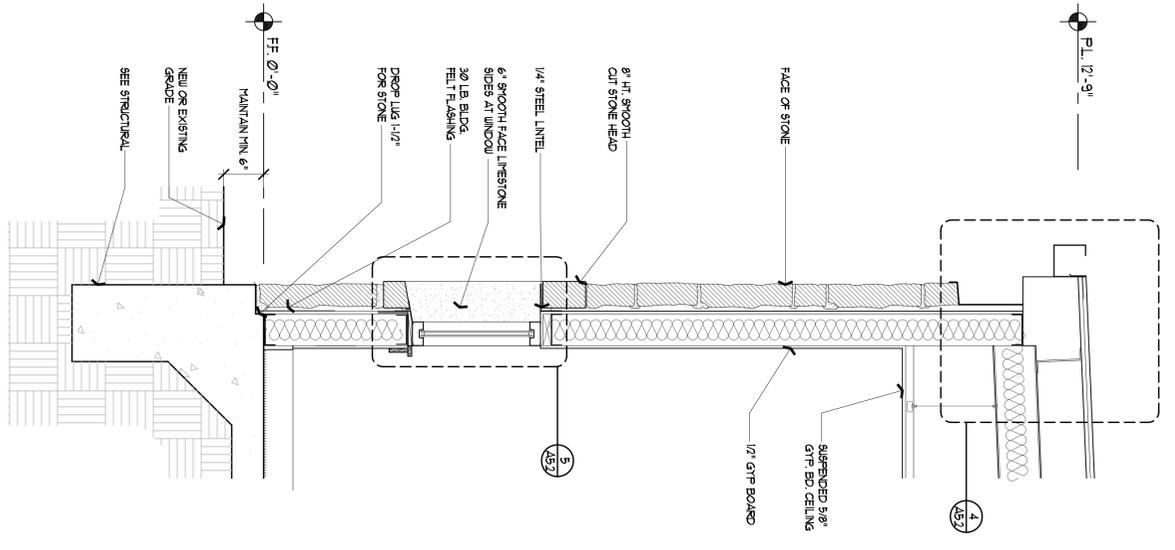
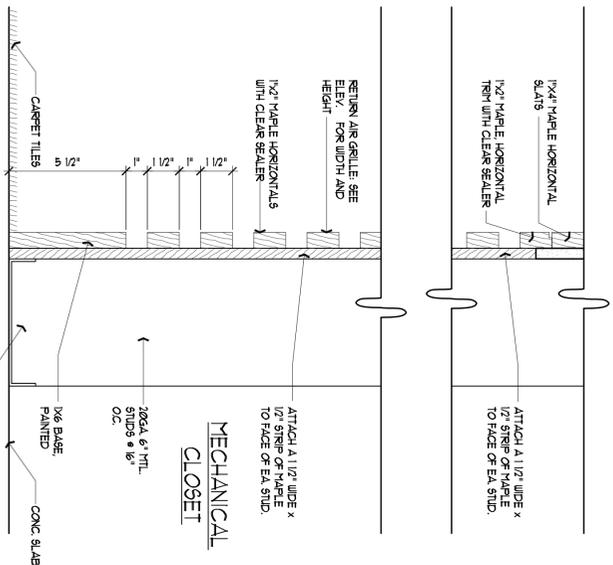
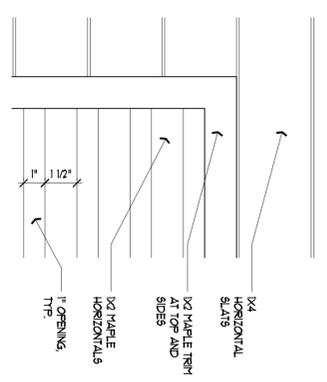
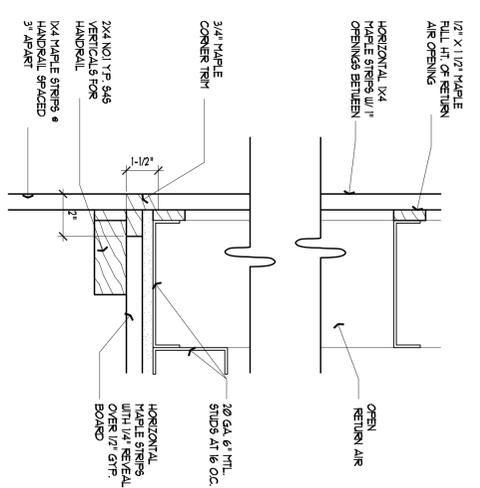
RICHARD MOGAS ARCHITECTURE AIA
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Proposal for 2013-1
LEON VALLEY LIBRARY
 CHILDREN'S WING ADDITION
 6425 Evers, Leon Valley, Texas 78238


WALL SECTIONS

SHEET TITLE


SHEET:
A-5.2
 13 OF 18
 Date: NOV 16, 2012




2 SECTION
 SCALE: 3/4" = 1'-0"

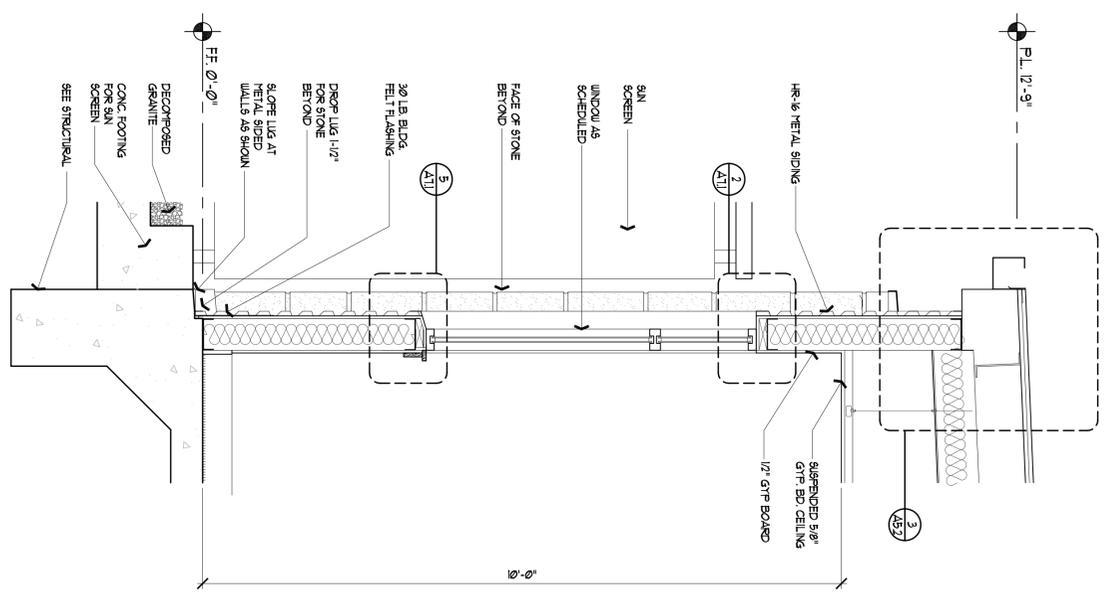


1 SECTION
 SCALE: 3/4" = 1'-0"

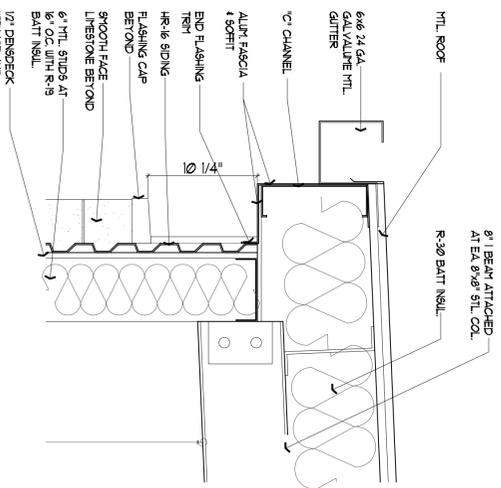


3 DETAIL
 SCALE: 1 1/2" = 1'-0"

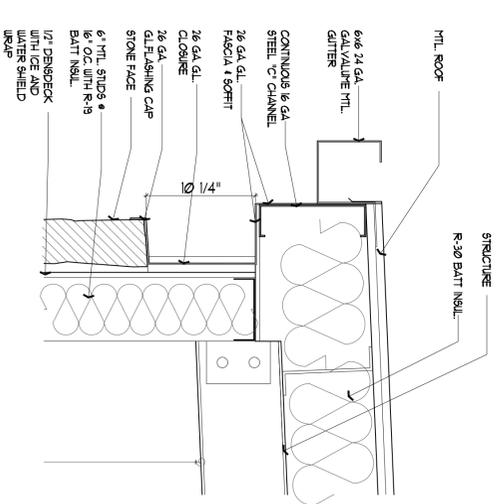


4 DETAIL
 SCALE: 1 1/2" = 1'-0"

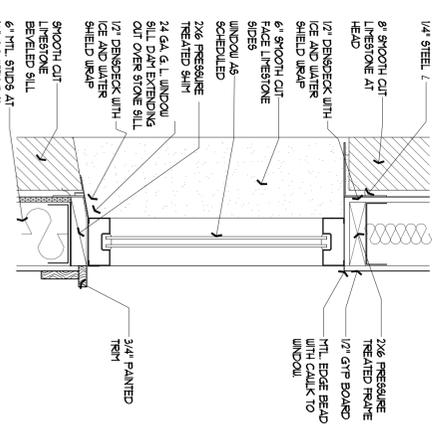


5 DETAIL
 SCALE: 1 1/2" = 1'-0"

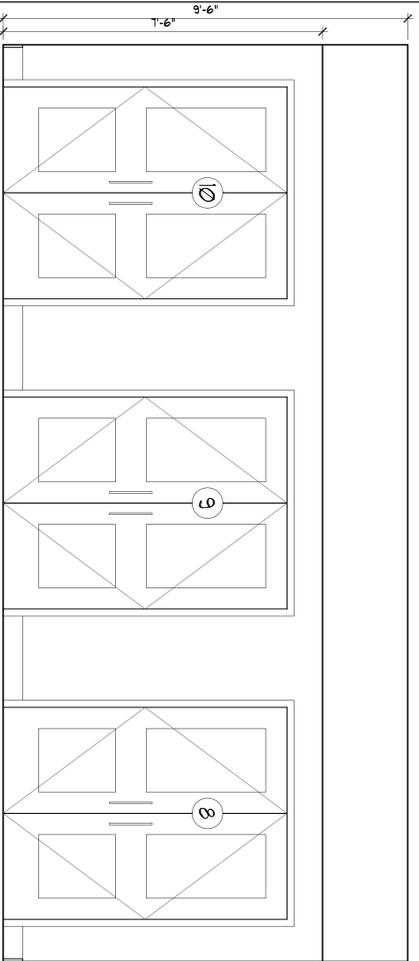


1 MEETING R.M.
SCALE: 1/2" = 1'-0"

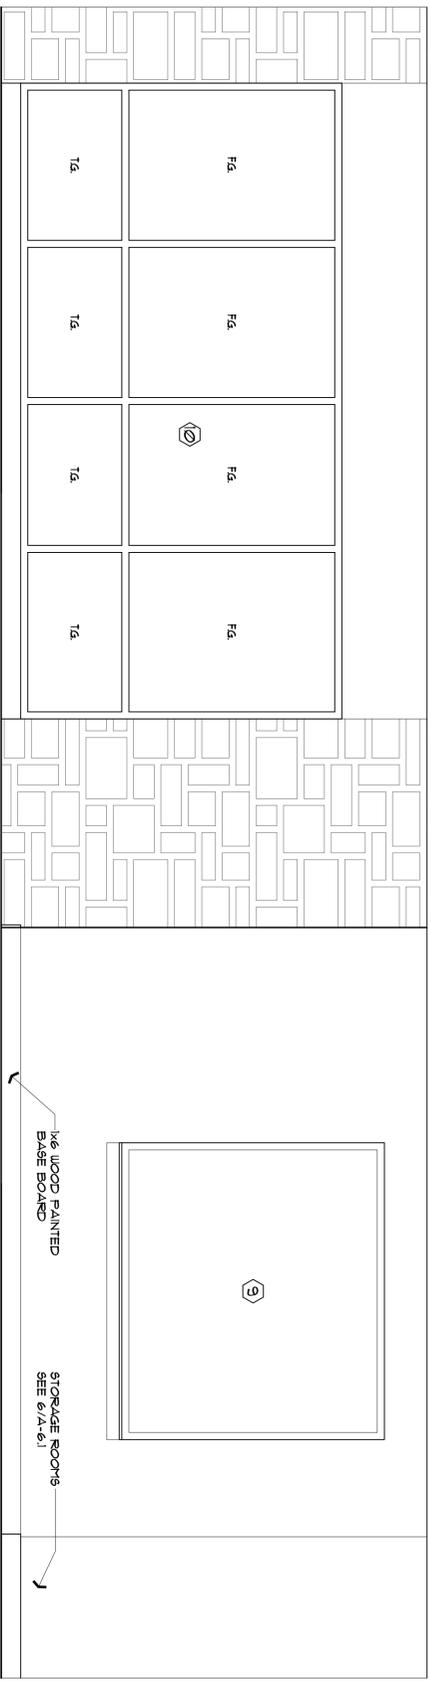


2 NORTH INTERIOR
SCALE: 1/2" = 1'-0"

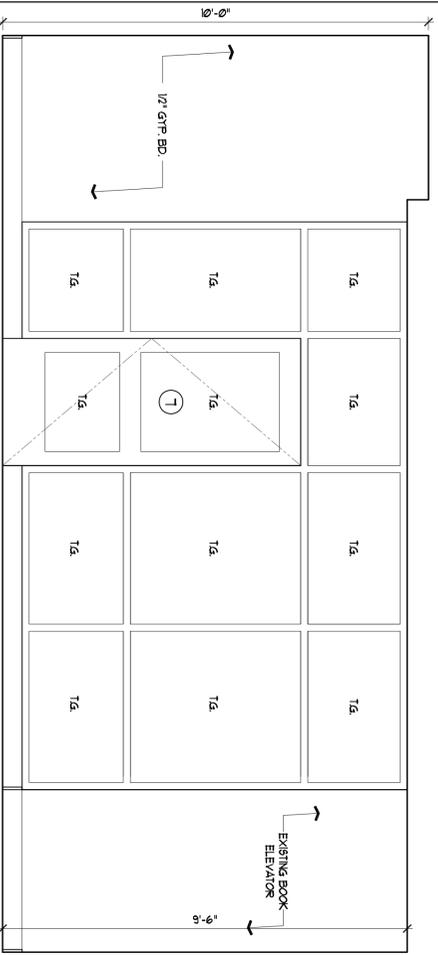


3 MEETING R.M.
SCALE: 1/2" = 1'-0"

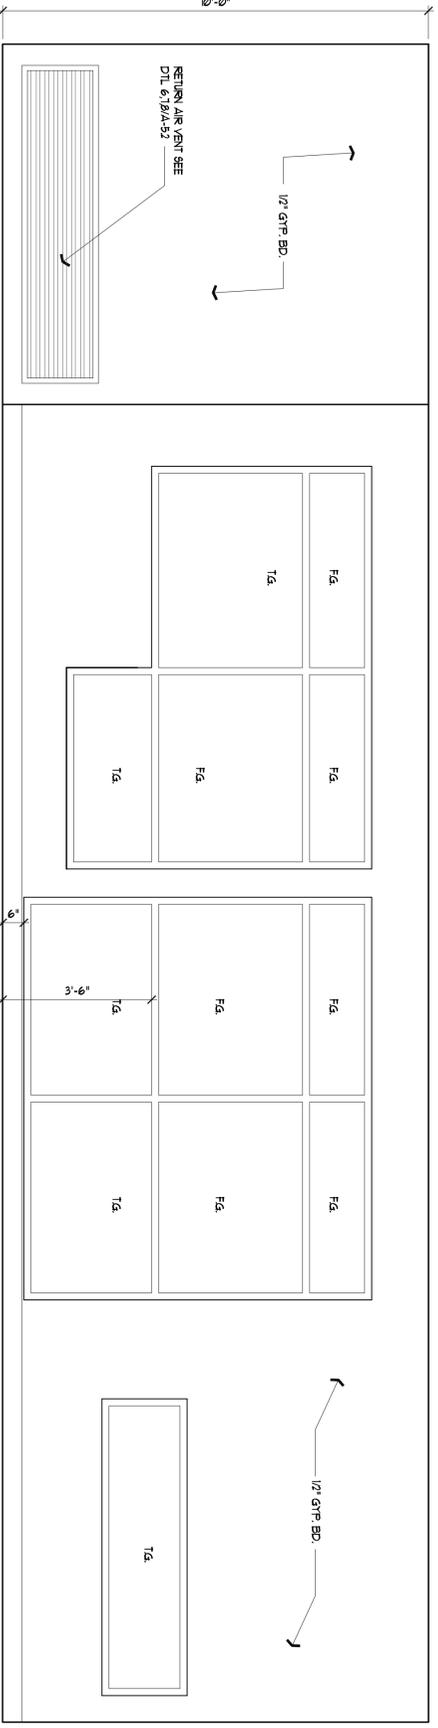

4 SOUTH INTERIOR
SCALE: 1/2" = 1'-0"

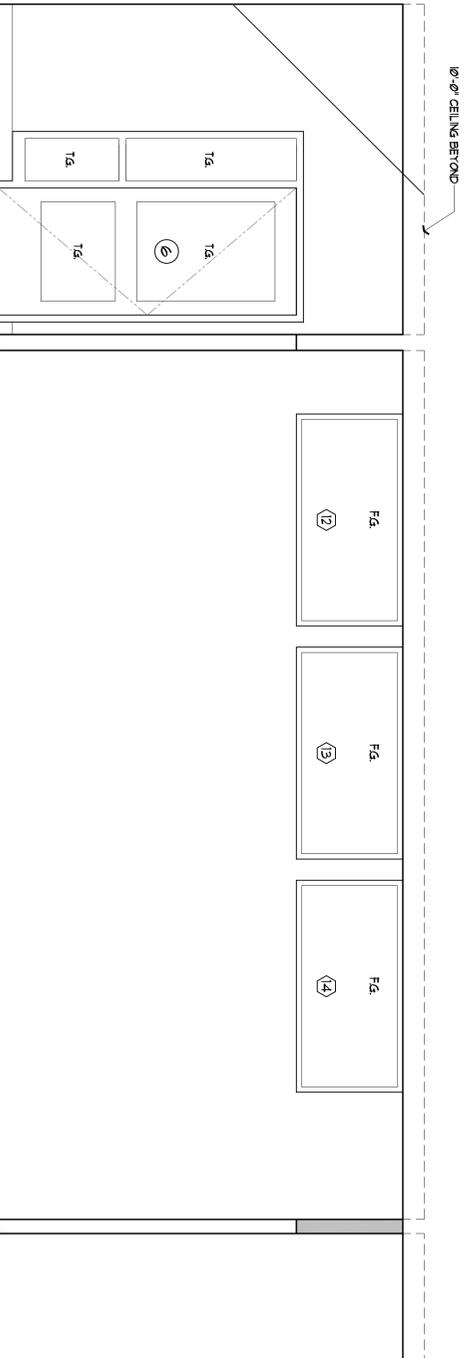

5 HALL
SCALE: 1/2" = 1'-0"

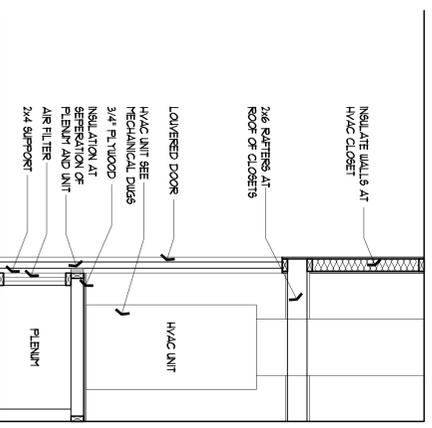


7 HVAC CLOSET
SCALE: 1/2" = 1'-0"

SHEET:	A-6.1
14 OF 18	
Date: NOV. 16, 2012	
SHEET TITLE	INTERIOR ELEVATIONS


Proposal for 2013-1
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1 EAST WALL
SCALE: 1/4" = 1'-0"



2 WEST WALL
SCALE: 1/4" = 1'-0"

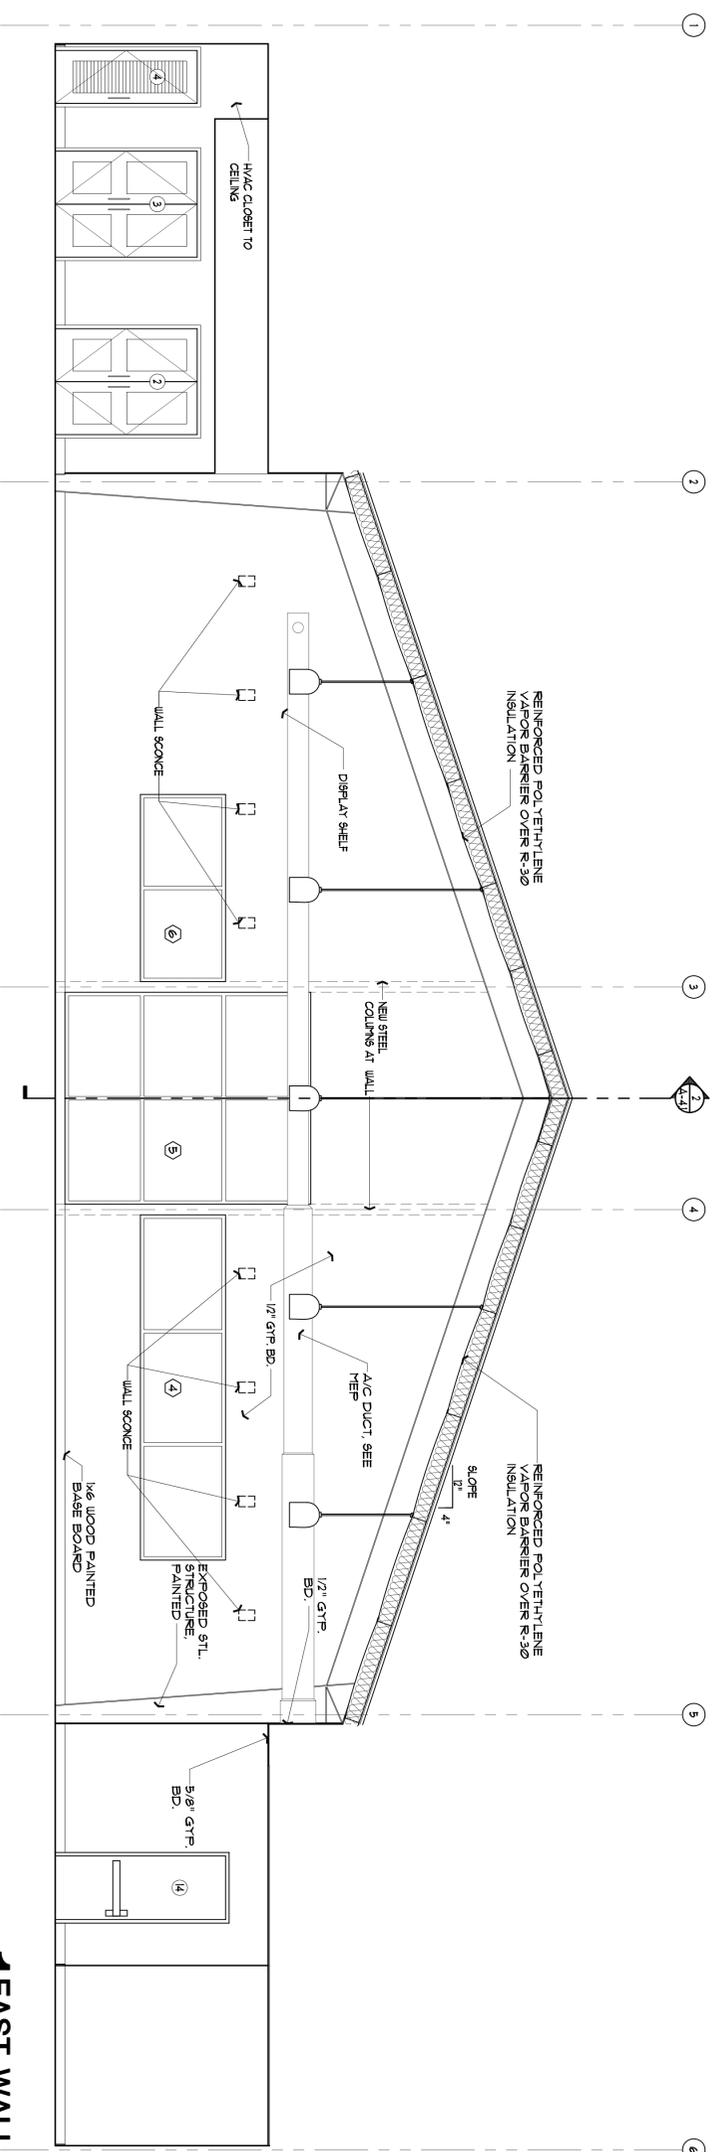

Expiration Date: 11/26/12
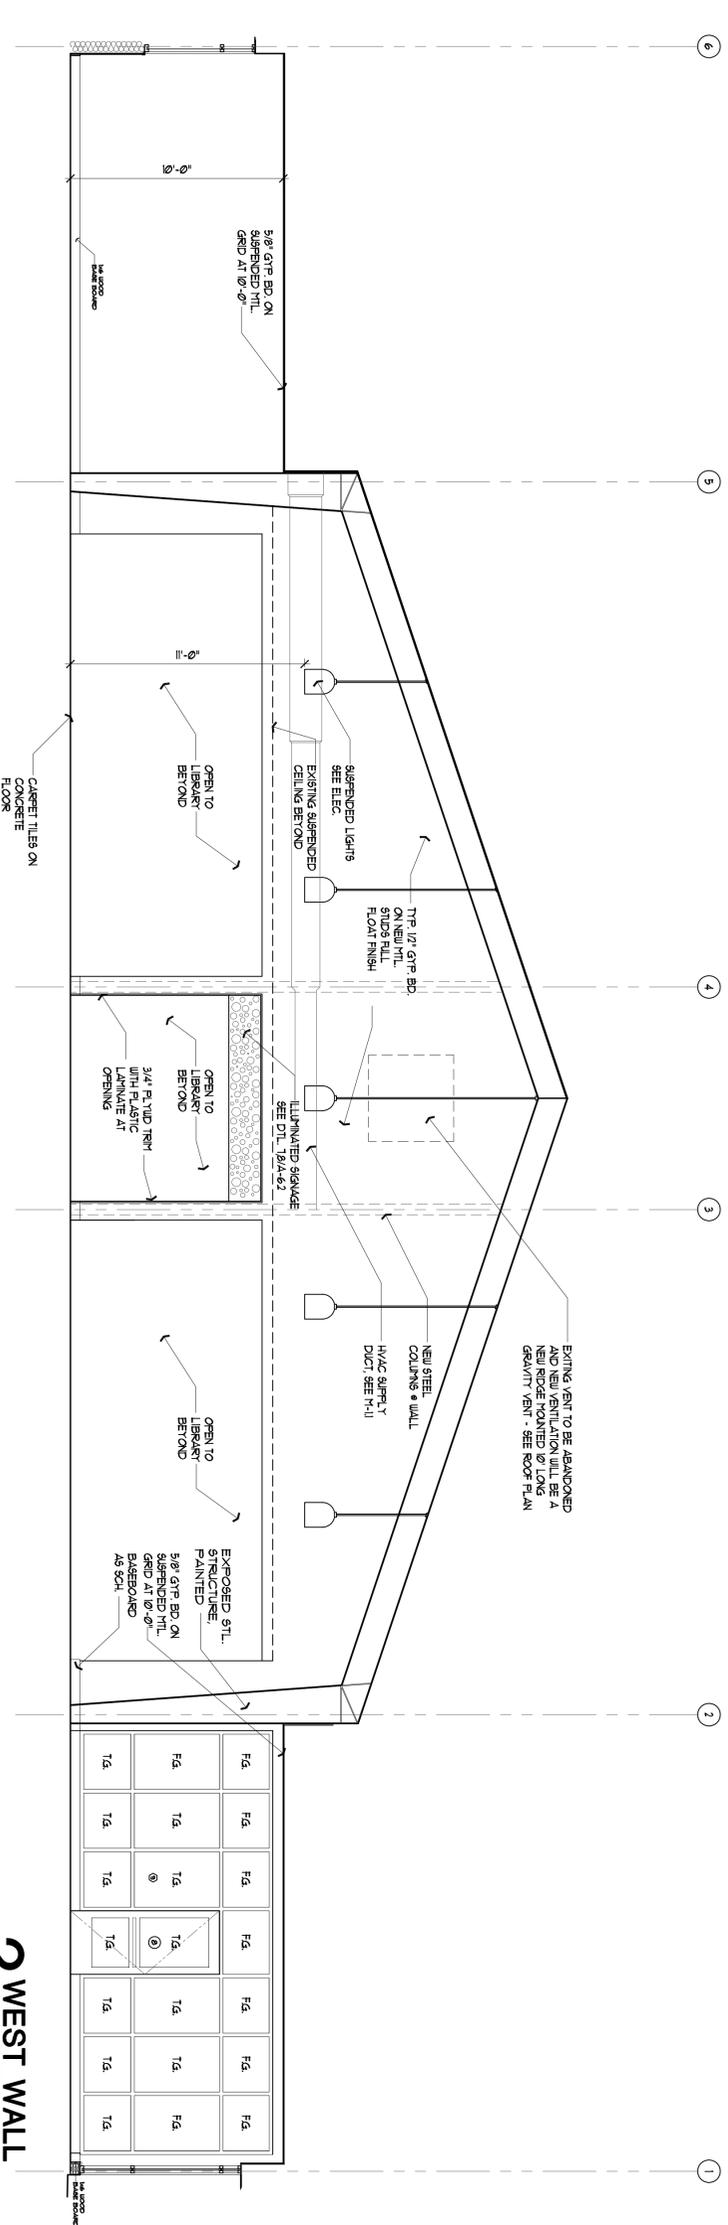
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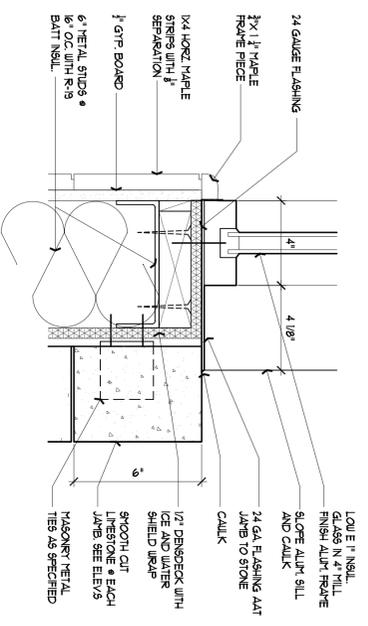
Proposal for 2013-1
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SHEET TITLE
INTERIOR ELEVATIONS


SHEET TITLE

CONSTRUCTION DOCUMENTS


SHEET:
A-6.3
16 OF 18
Date: NOV 16, 2012




1 JAMB AT WINDOW
SCALE: 3" = 1'-0"

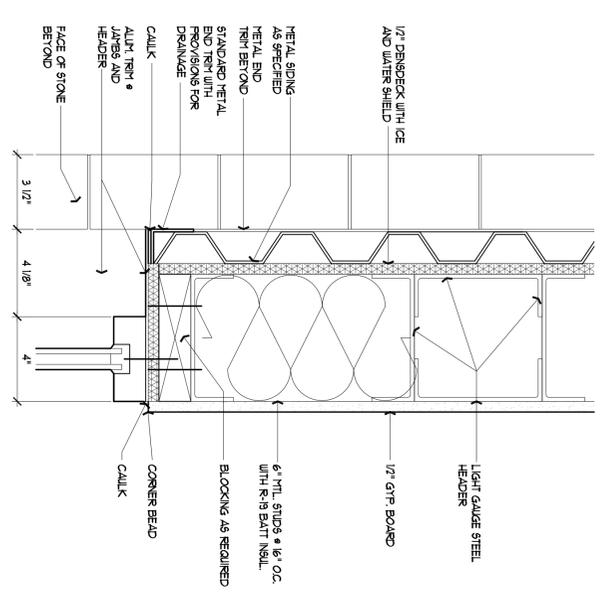


2 HEADER DETAIL
SCALE: 3" = 1'-0"

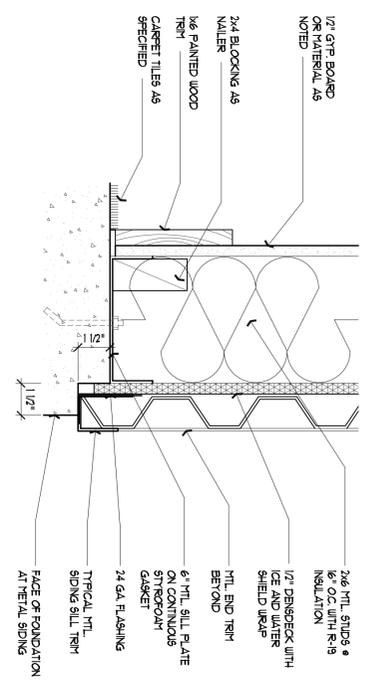



4 BASE DETAIL
SCALE: 3" = 1'-0"

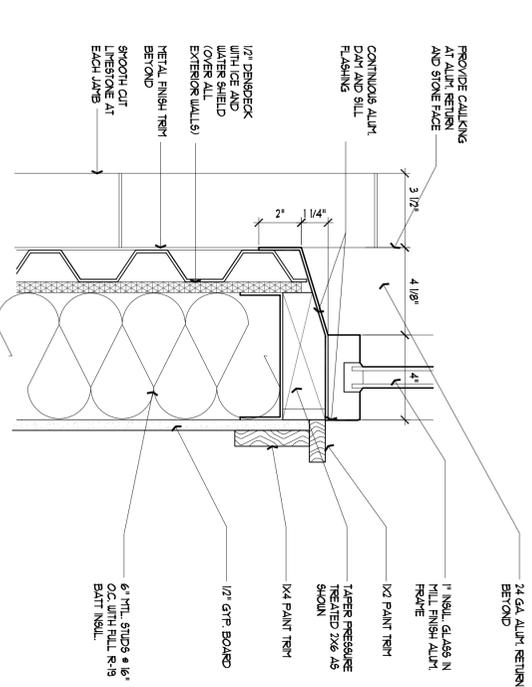


5 SILL DETAIL AT WINDOW
SCALE: 3" = 1'-0"

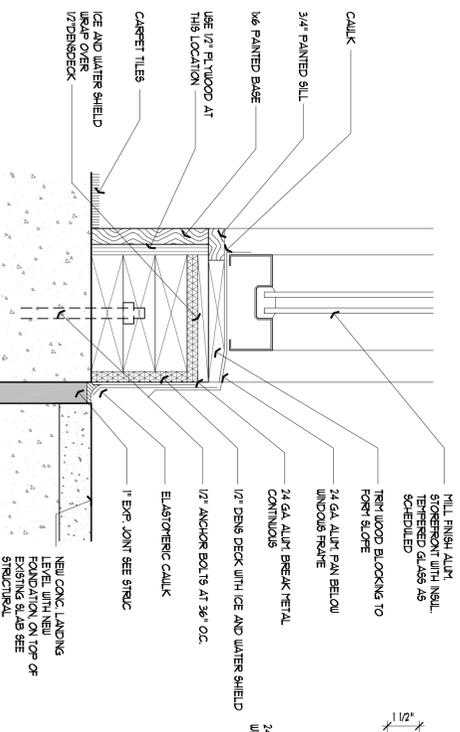


3 WALL DETAIL AT WEST ENTRY
SCALE: 3" = 1'-0"

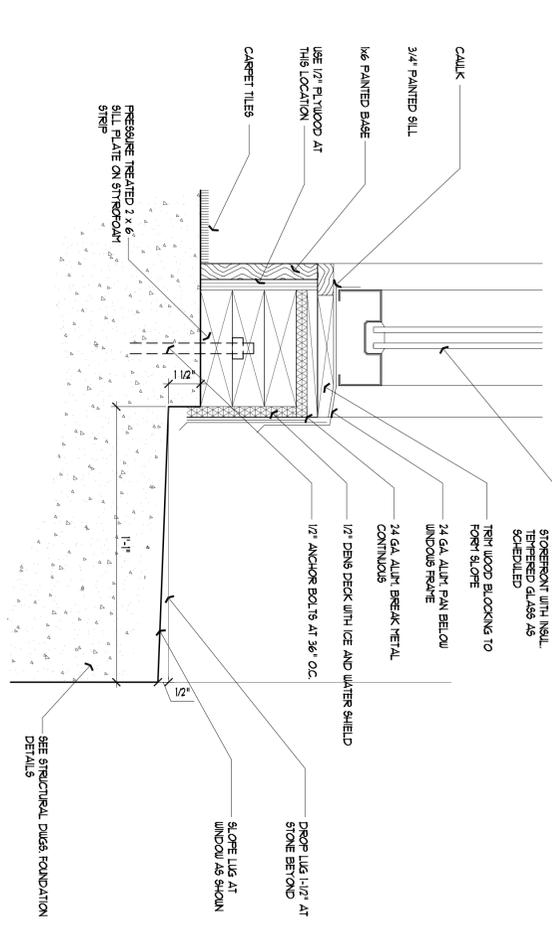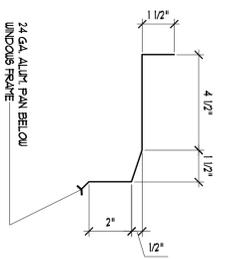

6 DETAIL AT NORTH WALL
SCALE: 3" = 1'-0"

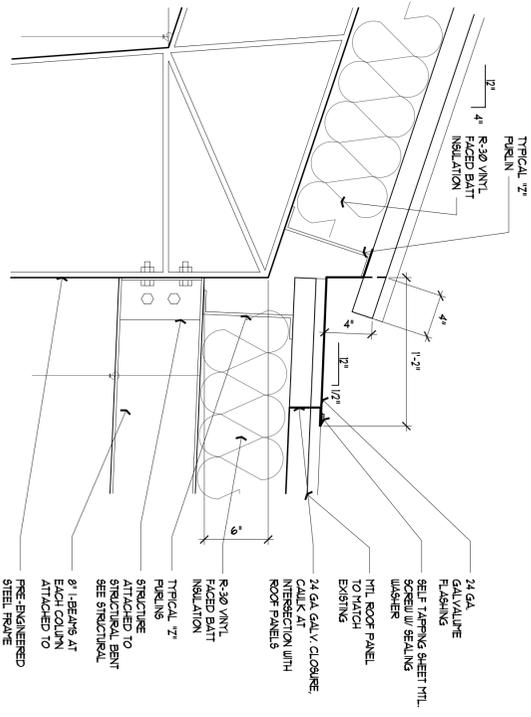

7 SECTION DETAIL
SCALE: 1 1/2" = 1'-0"

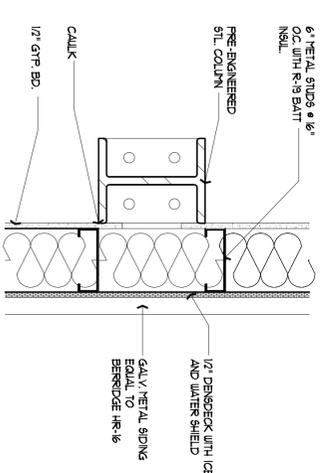

8 PLAN DETAIL AT STEEL COLUMN TYP.
SCALE: 1 1/2" = 1'-0"

ROOM FINISH SCHEDULE LOP - LIGHT ORANGE PEEL


No	Room Name	Flooring	Base	Utterure	North Wall	East Wall	South Wall	West Wall	Ceiling	Ceiling Ht.	REMARKS
01	CHILDREN'S WING	C.S.	WOOD	FF	GLB-PT	GLB-PT	GLB-PT	GLB-PT	EXP. STRUC. VARIES		
02	MECHANICAL ROOM	CONC.	WOOD	L.O.P.	GLB-PT	GLB-PT	GLB-PT	GLB-PT	10'-0"		
03	MEETING ROOM	C.S.	WOOD	FF	GLB-PT	GLB-PT	GLB-PT	GLB-PT	9'-6"		
04	WOMEN'S RESTROOM	VT.	C.T.	FF	GLB-PT	GLB-PT	GLB-PT	GLB-PT	9'-6"		C.T. WAINSCOTTING UP TO 3'-4"
05	MEN'S RESTROOM	VT.	C.T.	FF	GLB-PT	GLB-PT	GLB-PT	GLB-PT	9'-6"		C.T. WAINSCOTTING UP TO 3'-4"
06	CORRIDOR	C.S.	C.T.	FF	GLB-PT	GLB-PT	GLB-PT	GLB-PT	9'-6"		
07	JAN CLOSET	VT.	C.T.	FF	GLB-PT	GLB-PT	GLB-PT	GLB-PT	9'-6"		

DOOR SCHEDULE

No	Width	Height	Room Name	Type	Core	Glass	Finish	Thick	Core Finish	REMARKS
1	3'-0"	FR	1'-0"	MECHANICAL ROOM	STEEL	-	PAINT	1-3/4"	STEEL PAINT	1/2 GA. HOLLOW MTL. DOOR AND FRAME
2	2'-6"	FR	6'-8"	STORAGE CLOSET	A	WOOD	-	-	WOOD	SEE DOOR TYPE SCHED
3	2'-6"	FR	6'-8"	STORAGE CLOSET	A	WOOD	-	-	WOOD	SEE DOOR TYPE SCHED
4	2'-6"	FR	6'-8"	HYAC CLOSET	F	WOOD	-	-	WOOD	LOVISED DOOR
5	3'-0"	1'-0"	EXIT TO NORTH PORCH	D	ALUM.	TEMP.	SEAL-CLEAR	-	ALUM. MTL.	DOORS W/ EXIT DEVICE
6	3'-0"	1'-0"	HALL	B	WOOD	TEMP.	-	-	WOOD PAINT	NAT. FINISH MARBLE W/ GLASS PANELS
7	2'-6"	FR	6'-8"	STORAGE CLOSET	A	WOOD	-	-	WOOD PAINT	NAT. FINISH MARBLE W/ SOLID PANELS
8	2'-6"	FR	6'-8"	STORAGE CLOSET	A	WOOD	-	-	WOOD PAINT	NAT. FINISH MARBLE W/ SOLID PANELS
9	2'-6"	FR	6'-8"	STORAGE CLOSET	A	WOOD	-	-	WOOD PAINT	NAT. FINISH MARBLE W/ SOLID PANELS
10	3'-0"	6'-8"	JANITORS CLOSET	A	WOOD	-	SEAL-CLEAR	-	ALUM. MTL.	NAT. FINISH MARBLE W/ SOLID PANELS
11	3'-0"	6'-8"	JANITORS CLOSET	A	WOOD	-	SEAL-CLEAR	-	ALUM. MTL.	REUSE EXISTING DOOR
12	3'-0"	6'-8"	MEN TR	WOOD	-	-	-	-	STEEL PAINT	REUSE EXISTING DOOR
13	3'-0"	6'-8"	WOMEN TR	WOOD	-	-	-	-	STEEL PAINT	REUSE EXISTING DOOR
14	3'-0"	1'-0"	EMERGENCY EXIT	E	STEEL	-	PAINT	-	STEEL PAINT	1/2 GA. HOLLOW MTL. DOOR AND FRAME


FINISH LEGEND

FLOORING
 CONCRETE: UNFINISHED
 B.C.: BURNISHED CONCRETE
 C.S.: CARPET SQUARES
 V.T.: VINYL TILE
BASE:
 WOOD: 1 X 6 WOOD BASE-FRFP 1 PAINT
 C.T.: CERAMIC TILE
WALLS:
 GLB-PT: 1/2 GYP/9M WALL BOARD PAINTED BENJAMIN MOORE OR EQUAL AS SPECIFIED. GREEN WALL BOARD IN RESTROOMS.
 C.T.: 4 X 4 WHITE GLAZED CERAMIC WALL TILE WITH WHITE GROUT
 FF: FULL FLOAT
 L.O.P.: LIGHT ORANGE PEEL
CEILING:
 ACT: 2X4 ACOUSTIC CEILING TILES
 GLB-PT: 5/8" GYP/9M WALL BOARD PAINTED BENJAMIN MOORE OR EQUAL AS SPECIFIED.

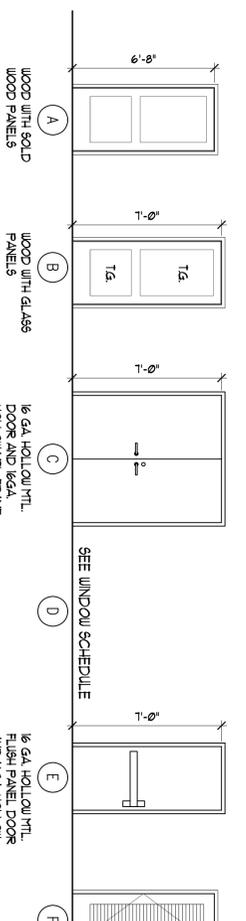

DOOR TYPES SCHEDULE

SCALE: 1/4" = 1'-0"

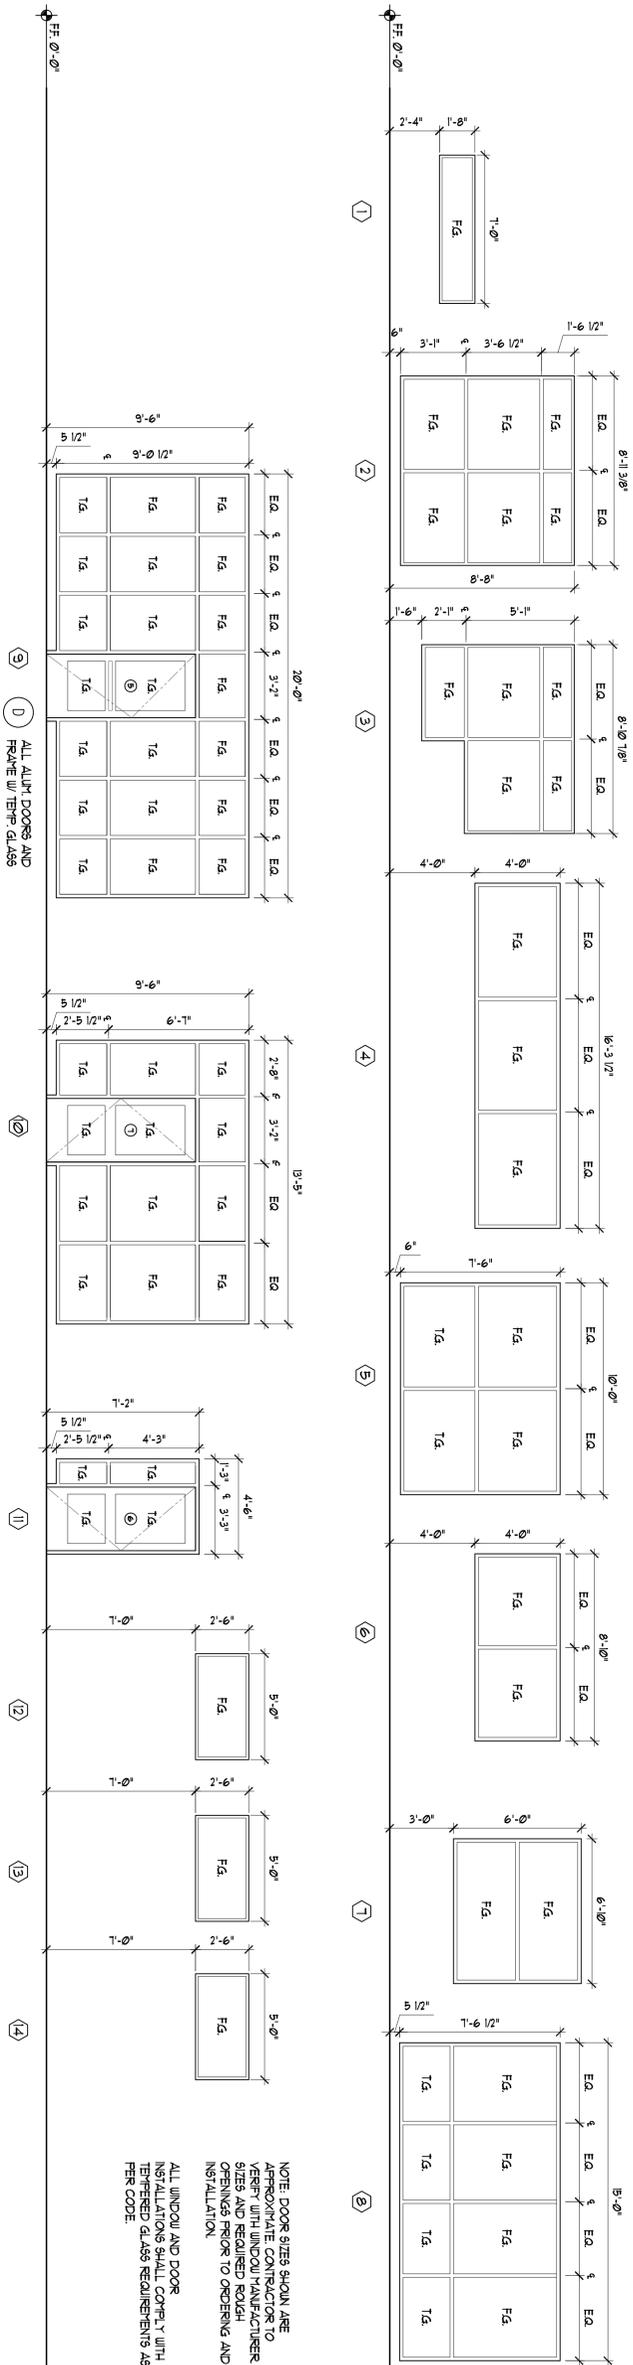

NOTE: DOOR TYPES SHOWN ARE APPROXIMATE CONSIDER TO VERIFY WITH WINDOW MANUFACTURER. SEE AND HOLLOW MTL. REQUIREMENTS PRIOR TO ORDERING AND INSTALLATION.
 ALL WINDOW AND DOOR MATERIALS SHALL COMPLY WITH MANUFACTURER'S REQUIREMENTS AS PER CODE.

2 WINDOW SCHEDULE

SCALE: 1/4" = 1'-0"

